

	EM40 RM1132 IONICS LAB 3.1.69 EQUIPMENT SCHEDULE												
ELECTRICAL DESIGNATION	LAB DESIGNATION	EQUIPMENT DESCRIPTION	PANEL CIRCUIT No.	WIRING & CONDUIT	CONNECTION TYPE	MOUNTING HEIGHT	REMARKS						
E01	EM40 3.1.69-1	FUME HOOD (2)					NOTE 1						
E02	EM40 3.1.69-2	EXPLOSION PROOF REFRIGERATOR					NOTE 1						
E03	EM40 3.1.69-3	COOLING BATH					NOTE 1						
E04	EM40 3.1.69-4	WATER STILL					NOTE 1						
E05		ROTARY EVAPORATOR					NOTE 1						
E06		VACUUM OVEN					NOTE 1						
E07		FORCED AIR DRYING OVEN					NOTE 1						
E08		ROTARY EVAPORATOR					NOTE 1						
E09		UNDERCOUNTER GLASS WASHER					NOTE 1						
E10		UV CURING SYSTEM					NOTE 1						
E11		AV-VIB SPECTROMETER					NOTE 1						

NOTE 1: BRANCH CIRCUITS FROM PANELBOARDS TO LAB EQUIPMENT SHOWN ON THIS SCHEDULE ARE NOT IN CONTRACT (TO BE PROVIDED BY OTHERS).

ELECTRICAL DESIGNATION	LAB DESIGNATION	EQUIPMENT DESCRIPTION	PANEL CIRCUIT No.	WIRING & CONDUIT	CONNECTION TYPE	MOUNTING HEIGHT	REMARKS
E12	EM30 3.1.32-1	DIMPLER					NOTE 1
E13	EM30 3.1.32-2	ION MILL					NOTE 1
E14	EM30 3.1.32-3	OSMIUM PLASMA COATER					NOTE 1
E15	EM30 3.1.32-4	FUME HOOD					NOTE 1
E16	EM30 3.1.32-5	VACUUM DESSICATOR					NOTE 1
E17	EM30 3.1.32-6	VAC SPUTTER COATERS					NOTE 1
E18	EM30	ULTRASONIC CLEANER					NOTE 1

EM30 RM1130 SEM/TEM PREP ROOM 3.1.32 EQUIPMENT SCHEDULE

NOTE 1: BRANCH CIRCUITS FROM PANELBOARDS TO LAB EQUIPMENT SHOWN ON THIS SCHEDULE ARE NOT IN CONTRACT (TO BE PROVIDED BY OTHERS).


GENERAL NOTES:

1. REFER TO E001 FOR ABBREVIATIONS, SYMBOLS AND GENERAL NOTES.

KEY NOTES:

- WIREMOLD G4000 OR EQUAL DUAL CHANNEL RACEWAY SERVING BOTH POWER AND TELECOM. PROVIDE A DUPLEX RECEPTACLE 2'-0" ON CENTER UNLESS OTHERWISE NOTED PROVIDE GFI TYPE RECEPTACLE WHEN LOCATED WITHIN 6'-0" OF A SINK.
- JUNCTION BOX LOCATED ABOVE CEILING FOR SERVICE CARRIER.
 REFER TO ARCHITECTURAL LAB EQUIPMENT DRAWINGS FOR EXACT LOCATION OF SERVICE CARRIERS.

3 COORDINATE MOUNTING REQUIREMENTS WITH FUMEHOOD SUPPLIER.

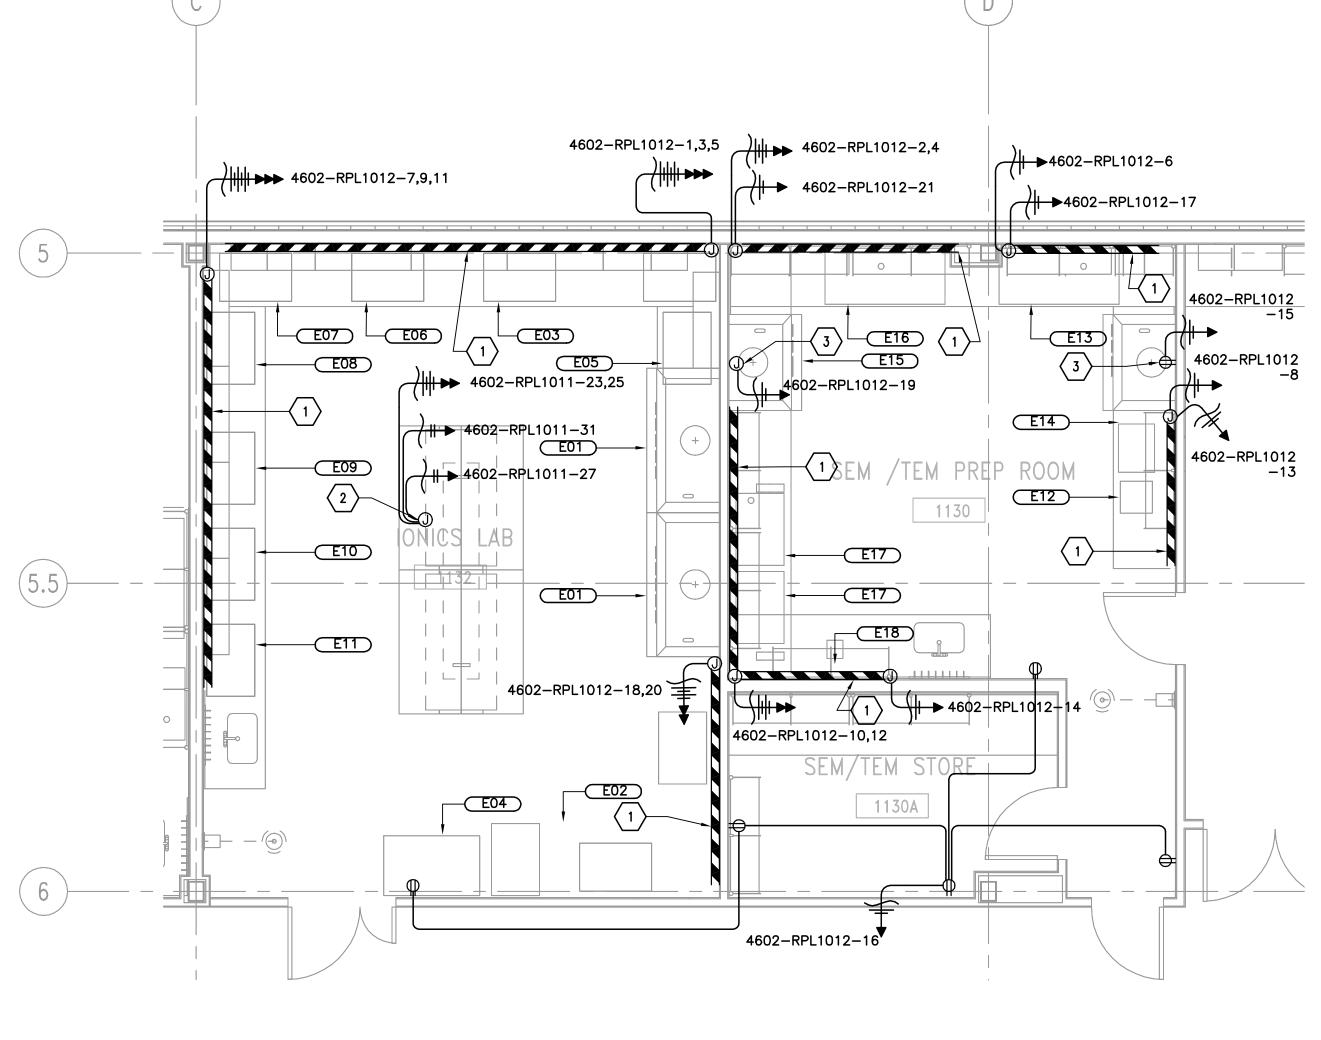



SIGNATURES ON INDEX SHEET INDICATE

AE: DATE: 06-11-08 ACCEPTANCE OF THIS SHEET

DESIGNED A. ALMANZA DRAWN R. POBLETE
CHECKED S. DIMACHKIEH 40 OF 81 scale: 1/4"=1'-0"

AE FIRM: HELLMUTH, OBATA, + KASSABAUM, Inc. APPROVAL RECOMMENDED: ROBERT T. MATHIS AD22 PROJECT A/E VINCENT JAMES GUARIN SAADEDDINE DIMACHKIEH AB22 GROUP LEAD DATE: APPROVAL RECOMMENDED: DENNIS FOSTER

AD22 SUPPORT A/E

APPROVAL RECOMMENDED:

MARK HENDERSON

AD22 TEAM LEAD DRAWING NO. FAC-A-4602-E611 SHEET 342 OF 445

EM30 RM1153 SALT FOG CHAMBERS 3.1.9 EQUIPMENT SCHEDULE ELECTRICAL LAB EQUIPMENT PANEL WIRING & CONNECTION MOUNTING REMARKS DESIGNATION | DESIGNATION | DESCRIPTION CIRCUIT No. CONDUIT HEIGHT EM30 UV CONDENSATION CHAMBER NOTE 1 3.1.9-1 EM30 CYCLICAL CORROSIONS, IMMERSION, NOTE 1 3.1.9-2 WATER STORAGE TANK EM30 HIGH HUMIDITY CHAMBER NOTE 1 3.1.9-3 EM30 SALT FOG CHAMBER NOTE 1 3.1.9-4 E05 NOTE 1

NOTE 1: BRANCH CIRCUITS FROM PANELBOARDS TO LAB EQUIPMENT SHOWN ON THIS SCHEDULE ARE NOT IN CONTRACT (TO BE PROVIDED BY OTHERS).

	EM4C) RM1131	COAT	TING SPRAY	TECH. 3.1.63	EQUIPMENT	SCHEDULE	
ELECTRICAL DESIGNATION	LAB DESIGNATION	EQUIPMENT DESCRIPTION		PANEL CIRCUIT No.	WIRING & CONDUIT	CONNECTION TYPE	MOUNTING HEIGHT	REMARKS
E06	NOT US	SED						

NOTE 1: BRANCH CIRCUITS FROM PANELBOARDS TO LAB EQUIPMENT SHOWN ON THIS SCHEDULE ARE NOT IN CONTRACT (TO BE PROVIDED BY OTHERS).

MSFC-FORM 232 REV. 8-21-89-RCL

	Е	M40 RM1157 CEF	RAMICS & AB	L MICROSCOF	Y 3.1.62 E	QUIPME	NT SCHEDULE
ELECTRICAL DESIGNATION	LAB DESIGNATION	EQUIPMENT DESCRIPTION	PANEL CIRCUIT No.	WIRING & CONDUIT	CONNECTION TYPE	MOUNTING HEIGHT	REMARKS
E07	EM40 3.1.62-1	MICROHARDNESS TESTER					NOTE 1
E08	EM40 3.1.62-2	OPTICAL MICROSCOPES w/PCs-STEM 1					NOTE 1
E09	EM40 3.1.62-3	OPTICAL MICROSCOPES w/PC-NIKON					NOTE 1

NOTE 1: BRANCH CIRCUITS FROM PANELBOARDS TO LAB EQUIPMENT SHOWN ON THIS SCHEDULE ARE NOT IN CONTRACT (TO BE PROVIDED BY OTHERS).


GENERAL NOTES:


1. REFER TO E001 FOR ABBREVIATIONS, SYMBOLS AND GENERAL NOTES.

G

KEY NOTES:

- WIREMOLD G4000 OR EQUAL DUAL CHANNEL RACEWAY SERVING BOTH POWER AND TELECOM. PROVIDE A DUPLEX RECEPTACLE 2'-0" ON CENTER UNLESS OTHERWISE NOTED PROVIDE GFI TYPE RECEPTACLE WHEN LOCATED WITHIN 6'-0" OF A SINK.
- 2 JUNCTION BOX LOCATED ABOVE CEILING FOR SERVICE CARRIER. REFER TO ARCHITECTURAL LAB EQUIPMENT DRAWINGS FOR EXACT LOCATION OF SERVICE CARRIERS.

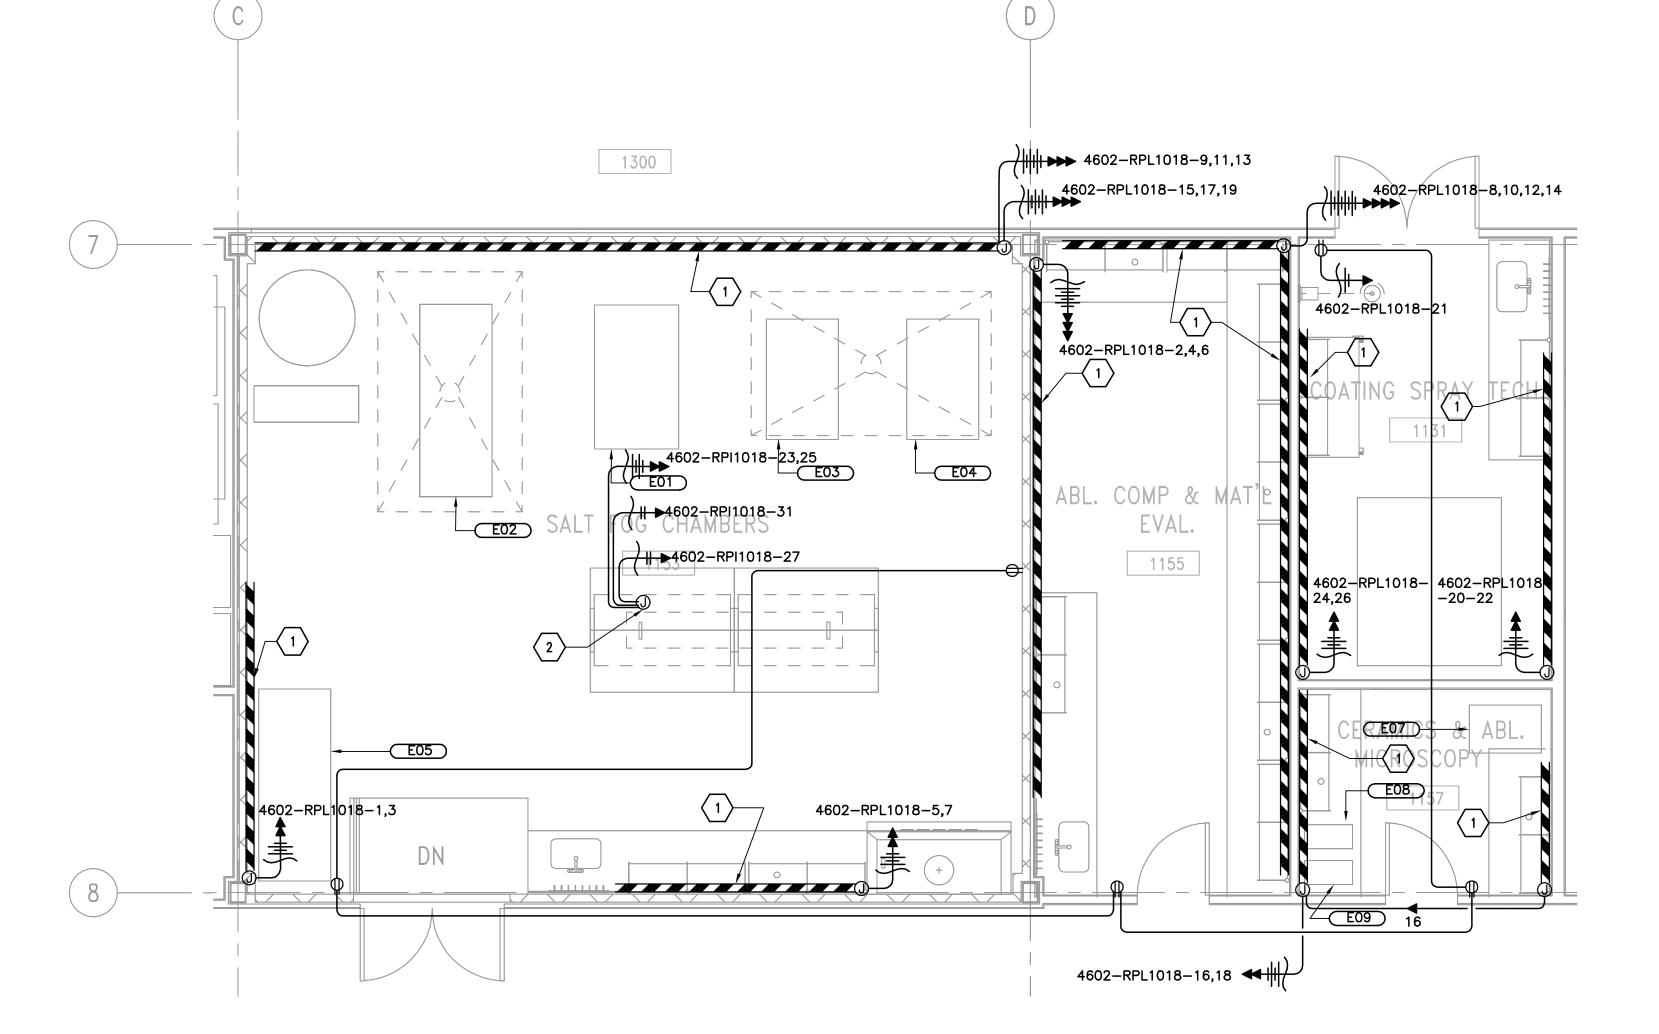

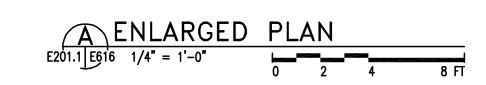



AE FIRM: HELLMUTH, OBATA, + KASSABAUM, Inc. APPROVAL RECOMMENDED:
ROBERT T. MATHIS
AD22 PROJECT A/E
APPROVAL RECOMMENDED: VINCENT JAMES GUARIN SAADEDDINE DIMACHKIEH SIGNATURES ON INDEX SHEET INDICATE ACCEPTANCE OF THIS SHEET

AE: DATE: 06-11-08

DESIGNED A. AI MAN7A AB22 GROUP LEAD DATE:

DRAWING NO. DENNIS FOSTER

AD22 SUPPORT A/E

APPROVAL RECOMMENDED:

MARK HENDERSON

AD22 TEAM LEAD

SPEC. NO. FAC M5030
 DRAWN
 R. POBLETE

 CHECKED
 S. DIMACHKIEH

 45 OF 81
 SCALE:
 1/4"=1'-0"

FAC-A-4602-E616 SHEET 347 OF 445

EM40 RM1152 PERM & HPLC TEST 3.1.68 EQUIPMENT SCHEDULE ELECTRICAL LAB EQUIPMENT PANEL WIRING & CONNECTION MOUNTING REMARKS DESIGNATION DESIGNATION DESCRIPTION CIRCUIT No. CONDUIT HEIGHT NOTE 1 EM40 HPLC w/PC 3.1.68-1 NOT USED EM40 MASS SPECTROMETER NOTE 1 3.1.68-3 EM40 RESIDUAL GAS ANALYZER NOTE 1 3.1.68-4

NOTE 1: BRANCH CIRCUITS FROM PANELBOARDS TO LAB EQUIPMENT SHOWN ON THIS SCHEDULE ARE NOT IN CONTRACT (TO BE PROVIDED BY OTHERS).

		EM40 RM1154	FIBER & HIGH	TEMP PROCESS	S LAB 3.1.6	1 EQL	JIPMENT SCHEDULE
ELECTRICAL DESIGNATION	LAB DESIGNATION	EQUIPMENT DESCRIPTION	PANEL CIRCUIT No.	WIRING & CONDUIT	CONNECTION TYPE	MOUNTING HEIGHT	REMARKS
E05	EM40 3.1.61-1	FIBER PROCESSING LAB CART					NOTE 1
E06	EM40 3.1.61-2	COATING SYSTEM					NOTE 1
E07	EM40 3.1.61-3	LINBERG OVEN					NOTE 1
E08	EM40 3.1.61-4	LABANCO DESSICATOR					NOTE 1
E09	EM40 3.1.61-5	ISOMET PRECISION SAW					NOTE 1
E10	EM40 3.1.61-6	REFRIGERATOR					NOTE 1
E11	EM40 3.1.61-7	FUMEHOOD					NOTE 1

NOTE 1: BRANCH CIRCUITS FROM PANELBOARDS TO LAB EQUIPMENT SHOWN ON THIS SCHEDULE ARE NOT IN CONTRACT (TO BE PROVIDED BY OTHERS).

EM40 FURNACE 3.1.61-8

EM40 FIBER PULLER 3.1.61-9

NOT USED.

	E	M40 RM1156 HI	GH TEMP PER	RM 3.1.60 EQU	JIPMENT SCH	HEDULE	_ _ _
ELECTRICAL DESIGNATION	LAB DESIGNATION	EQUIPMENT DESCRIPTION	PANEL CIRCUIT No.	WIRING & CONDUIT	CONNECTION TYPE	MOUNTING HEIGHT	REMARKS
E15	EM40 3.1.60-1	HT. PERMEABILITY					NOTE 1
E16	EM40 3.1.60-2	FUMEHOOD					

NOTE 1: BRANCH CIRCUITS FROM PANELBOARDS TO LAB EQUIPMENT SHOWN ON THIS SCHEDULE ARE NOT IN CONTRACT (TO BE PROVIDED BY OTHERS).

D

	E	M30 RM1158 HIGH	TEMP MAT	T'LS CHARACT.	3.1.49 EQU	IPMEN'	T SCHEDULE
ELECTRICAL DESIGNATION	LAB DESIGNATION	EQUIPMENT DESCRIPTION	PANEL CIRCUIT No.	WIRING & CONDUIT	CONNECTION TYPE	MOUNTING HEIGHT	REMARKS
E17	EM30 3.1.49-1	TORSION VISCOMETER					NOTE 1
E18	EM30 3.1.49-2	OLIS SPECTROPHOTOMETER & CP					NOTE 1
E19	EM30 3.1.49-3	HIGH TEMP THERMAL CONDUCTIVITY					NOTE 1

NOTE 1: BRANCH CIRCUITS FROM PANELBOARDS TO LAB EQUIPMENT SHOWN ON THIS SCHEDULE ARE NOT IN CONTRACT (TO BE PROVIDED BY OTHERS).

GENERAL NOTES:


1. REFER TO E001 FOR ABBREVIATIONS, SYMBOLS AND GENERAL NOTES.

G

- 2. PROVIDE DUPLEX ON RACEWAY EVERY 12" ON CENTER.
- 3. PROVIDE GFI OUTLET IN RACEWAY WHEN WITHIN 72" OF SINK.

KEY NOTES:


- WIREMOLD G4000 OR EQUAL DUAL CHANNEL RACEWAY SERVING BOTH POWER AND TELECOM. PROVIDE A DUPLEX RECEPTACLE 2'-0" ON CENTER UNLESS OTHERWISE NOTED PROVIDE GFI TYPE RECEPTACLE WHEN LOCATED WITHIN 6'-0" OF A SINK.
- JUNCTION BOX LOCATED ABOVE CEILING FOR SERVICE CARRIER. REFER TO THE ARCHITECTURAL LAB EQUIPMENT DRAWINGS FOR EXACT LOCATION OF SERVICE CARRIERS.
- $\sqrt{3}$ PROVIDE JUNCTION BOX FOR OXYGEN SENSOR.

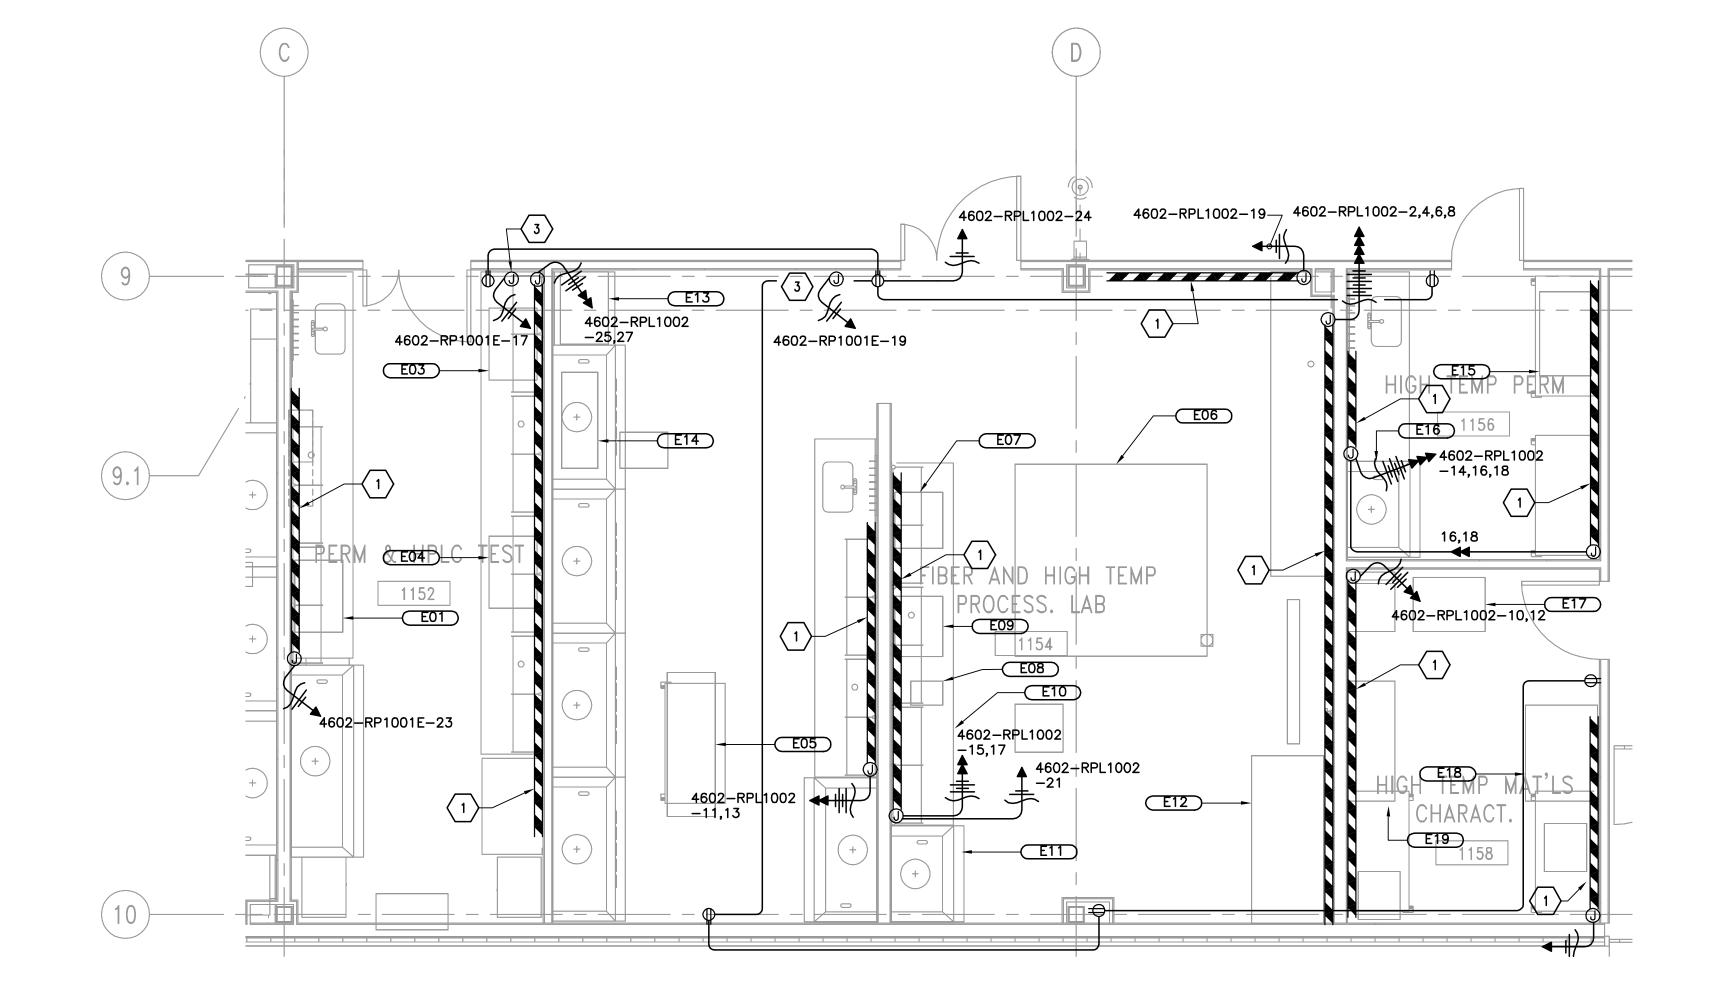


NOTE 1

NOTE 1

NOTE 1

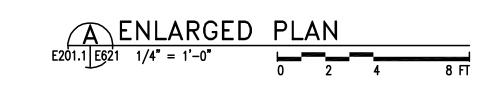

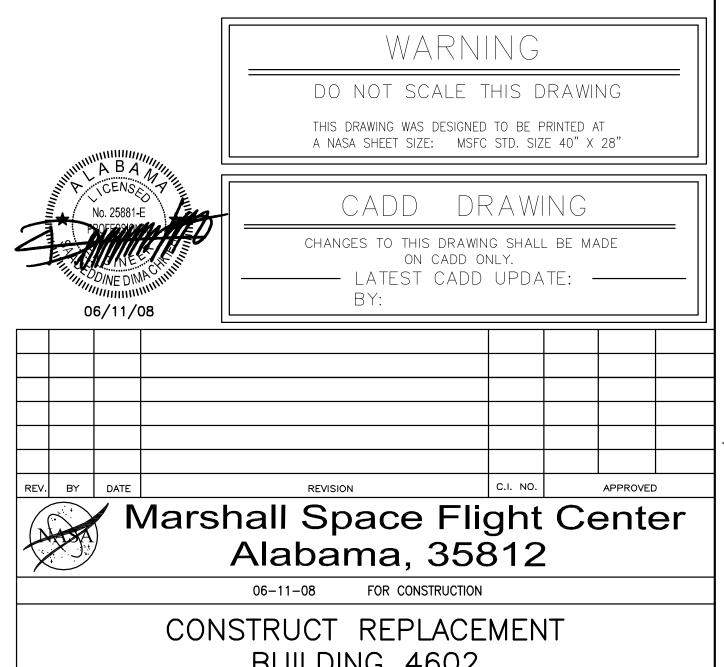

BUILDING 4602

ENLARGED PLANS

SPEC. NO. FAC M5030

AE FIRM: HELLMUTH, OBATA, + KASSABAUM, Inc. APPROVAL RECOMMENDED: ROBERT T. MATHIS AD22 PROJECT A/E VINCENT JAMES GUARIN SAADEDDINE DIMACHKIEH AB22 GROUP LEAD DATE: APPROVAL RECOMMENDED: SIGNATURES ON INDEX SHEET INDICATE AE: DATE: 06-11-08 DENNIS FOSTER

AD22 SUPPORT A/E

APPROVAL RECOMMENDED: DRAWING NO. DESIGNED A. ALMANZA PRAWN R. POBLETE
CHECKED S. DIMACHKIEH FAC-A-4602-E621 MARK HENDERSON AD22 TEAM LEAD 50 OF 81 SCALE: 1/4"=1'-0" SHEET 352 OF 445

ACCEPTANCE OF THIS SHEET

EM30 RM1168 PLATING ANALYSIS 3.1.13 EQUIPMENT SCHEDULE ELECTRICAL LAB EQUIPMENT PANEL WIRING & CONNECTION MOUNTING REMARKS DESIGNATION | DESIGNATION | DESCRIPTION CIRCUIT No. CONDUIT HEIGHT EM30 TEMPERATURE CONTROLLERS NOTE 1 3.1.12-1 EM30 PUMPS NOTE 1 3.1.12-2 EM30 TANKS NOTE 1 3.1.12-3 EM30 RO/DI WATER NOTE 1 3.1.12-6 EM30 ROTATORS NOTE 1 3.1.12-7 E06 EM30 BALANCE (2) NOTE 1

	3.1.12-8															
NOTE 1: BRANC	H CIRCUITS	FROM	PANELBOARDS	TO LAB	EQUIPMENT	SHOWN	ON TH	S SCHEDULE	ARE	NOT IN	CONTRACT	(то ве	PROVIDED	BY (OTHERS).	

	EM40 F	RM1171.1 & 1204 THEF	RMAL VACUUM T	EST LAB & EQUIP.	ROOM 3.1.66,67	EQUIPN	MENT SCHEDULE
ELECTRICAL DESIGNATION	LAB DESIGNATION	EQUIPMENT DESCRIPTION	PANEL CIRCUIT No.	WIRING & CONDUIT	CONNECTION TYPE	MOUNTING HEIGHT	REMARKS
E07	EM40 3.1.67	VACUUM PUMPS					NOTE 1
E08	EM40 3.1.67	VACUUM PUMPS					NOTE 1
E09	EM40 3.1.67	VACUUM PUMPS					NOTE 1
E10		DATA AQUISITION UNIT					NOTE 1

NOTE 1: BRANCH CIRCUITS FROM PANELBOARDS TO LAB EQUIPMENT SHOWN ON THIS SCHEDULE ARE NOT IN CONTRACT (TO BE PROVIDED BY OTHERS).


GENERAL NOTES:


1. REFER TO E001 FOR ABBREVIATIONS, SYMBOLS AND GENERAL NOTES.


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KEY NOTES:

- WIREMOLD G4000 OR EQUAL DUAL CHANNEL RACEWAY SERVING BOTH POWER AND TELECOM. PROVIDE A DUPLEX RECEPTACLE 2'-0" ON CENTER UNLESS OTHERWISE NOTED PROVIDE GFI TYPE RECEPTACLE WHEN LOCATED WITHIN 6'-0" OF A SINK.
- JUNCTION BOX LOCATED ABOVE CEILING FOR SERVICE CARRIER.
 REFER TO ARCHITECTURAL LAB EQUIPMENT DRAWINGS FOR EXACT LOCATION OF SERVICE CARRIERS.
- 3 PROVIDE JUNCTION BOX FOR OXYGEN SENSOR.



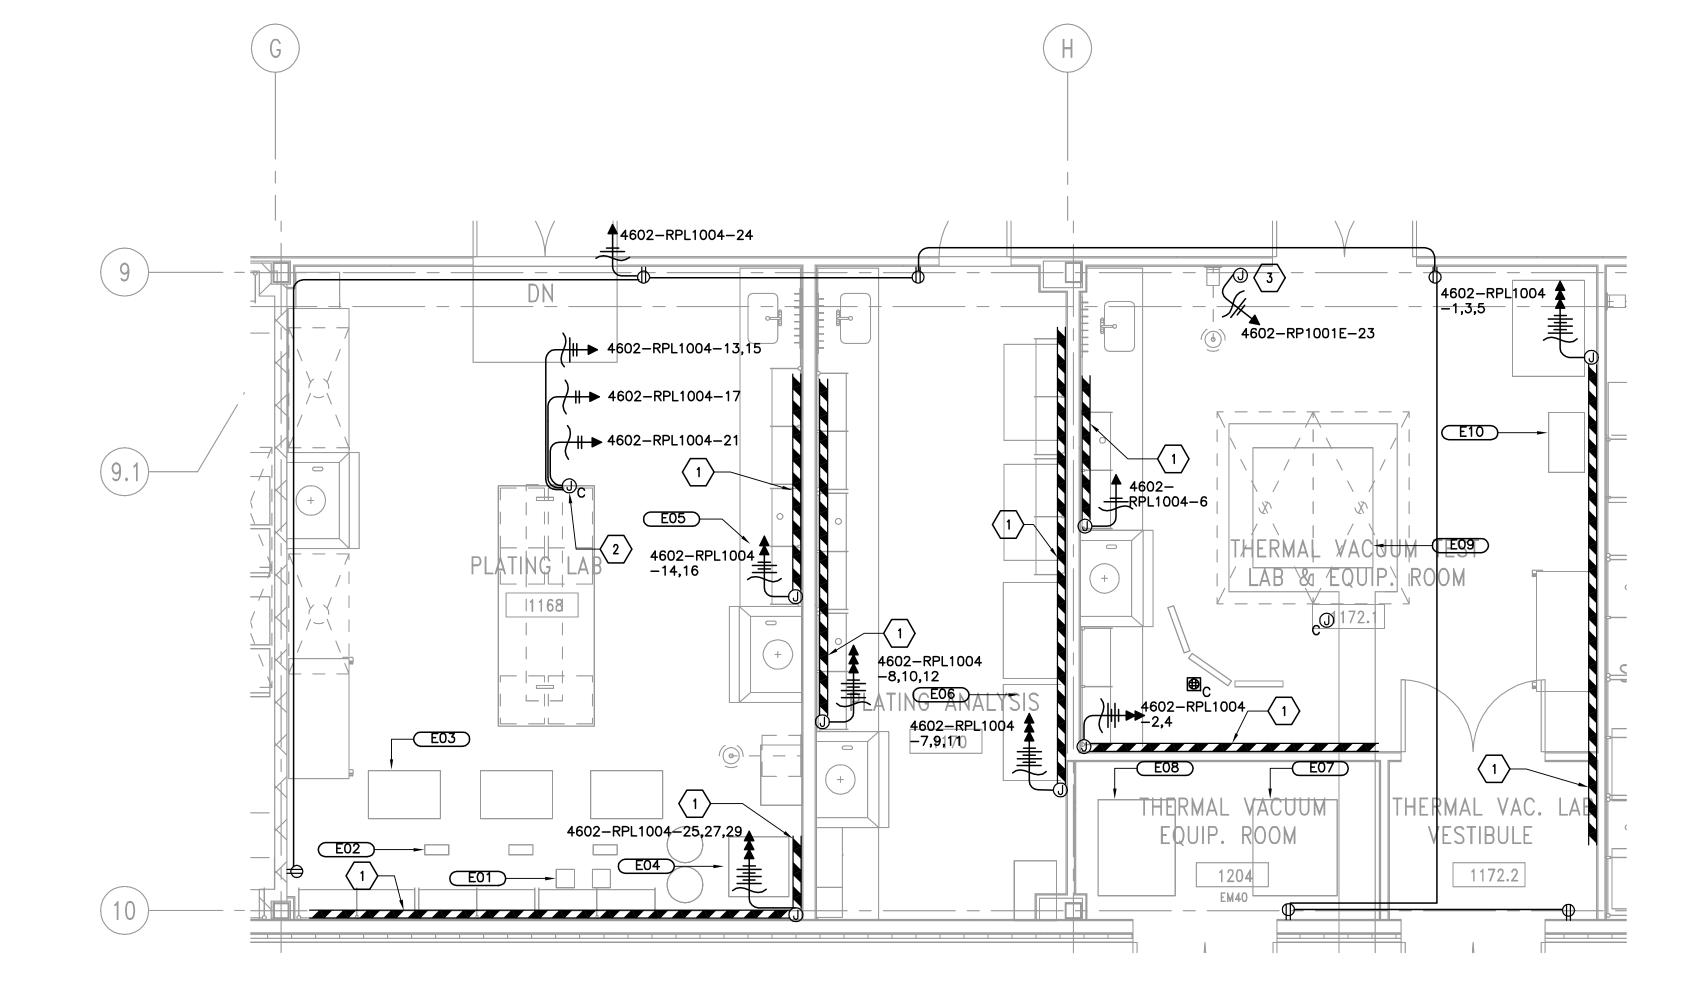

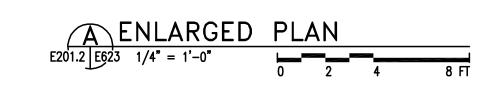

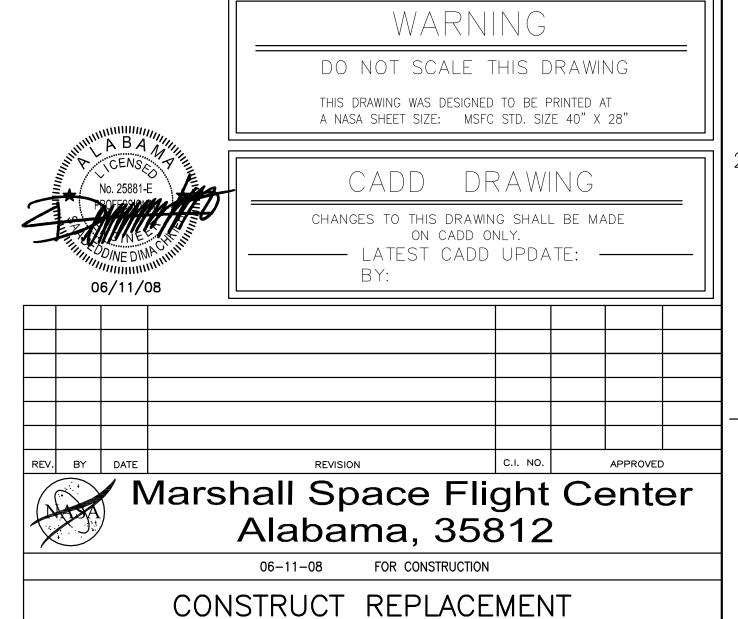CONSTRUCT REPLACEMENT BUILDING 4602

ENLARGED PLANS

AE FIRM: HELLMUTH, OBATA, + KASSABAUM, Inc. APPROVAL RECOMMENDED: ROBERT T. MATHIS AD22 PROJECT A/E VINCENT JAMES GUARIN SAADEDDINE DIMACHKIEH SIGNATURES ON INDEX SHEET INDICATE

ACCEPTANCE OF THE SHEET AB22 GROUP LEAD DATE: APPROVAL RECOMMENDED: DENNIS FOSTER

AD22 SUPPORT A/E

APPROVAL RECOMMENDED:

MARK HENDERSON

AD22 TEAM LEAD DRAWING NO. ACCEPTANCE OF THIS SHEET DESIGNED A. ALMANZA PRAWN R. POBLETE
CHECKED S. DIMACHKIEH FAC - A-4602-E623 52 OF 81 scale: 1/4"=1'-0" SHEET 354 OF 445 SPEC. NO. FAC M5030

	EM30 RM1174 SAMPLE POLISHING & ETCHING 3.1.47 EQUIPMENT SCHEDULE													
ELECTRICAL DESIGNATION	LAB DESIGNATION	EQUIPMENT DESCRIPTION	PANEL CIRCUIT No.	WIRING & CONDUIT	CONNECTION TYPE	MOUNTING HEIGHT	REMARKS							
E01	EM30 3.1.47-1	STRUERS LAB PRESS 3					NOTE 1							
E02	EM30 3.1.47-2	STRUERS ROTOPOL 31					NOTE 1							
E03	EM30 3.1.47-3	STRUERS LABPOL 21					NOTE 1							
E04	EM30 3.1.47-4	STRUERS ACCUTOM 5					NOTE 1							
E05	EM30 3.1.47-5	FUMEHOOD					NOTE 1							
E06	EM30 3.1.47-6	FUME HOOD					NOTE 1							
E07	EM30 3.1.47-7	POLISHING MACHINE					NOTE 1							
E08	EM30 3.1.47-8	VAULT, MOSLER					NOTE 1							

	0.1117															
NOTE 1: BRAN	ICH CIRCUITS	FROM	PANELBOARDS	TO LAE	B EQUIPMENT	SHOWN	ON TH	S SCHEDULI	E ARE	NOT IN	CONTRACT	(TO BE	PROVIDED	BY OT	HERS).	

		M40 RM1176 ELA	ASTOMERIC N	MATERIALS LAB	3.1.70 EQL	JIPMEN ⁻	T SCHEDULE
ELECTRICAL DESIGNATION	LAB DESIGNATION	EQUIPMENT DESCRIPTION	PANEL CIRCUIT No.	WIRING & CONDUIT	CONNECTION TYPE	MOUNTING HEIGHT	REMARKS
E09	EM40 3.1.70-1	RUBBER CALENDAR ROLL MILL					NOTE 1
E10		NOT USED					
E11		NOT USED					
E12	EM40 3.1.70-3	PORTABLE HEPA DUST COLLCTOR (IN HOOD)					NOTE 1


NOTE 1: BRANCH CIRCUITS FROM PANELBOARDS TO LAB EQUIPMENT SHOWN ON THIS SCHEDULE ARE NOT IN CONTRACT (TO BE PROVIDED BY OTHERS).

GENERAL NOTES:


- 1. REFER TO E001 FOR ABBREVIATIONS, SYMBOLS AND GENERAL NOTES.
- 2. PROVIDE DUPLEX ON RACEWAY EVERY 12" ON CENTER.
- 3. PROVIDE GFI OUTLET IN RACEWAY WHEN WITHIN 72" OF SINK.

KEY NOTES:

- WIREMOLD G4000 OR EQUAL DUAL CHANNEL RACEWAY SERVING BOTH POWER AND TELECOM. PROVIDE A DUPLEX RECEPTACLE 2'-0" ON CENTER UNLESS OTHERWISE NOTED PROVIDE GFI TYPE RECEPTACLE WHEN LOCATED WITHIN 6'-0" OF A SINK.
- JUNCTION BOX LOCATED ABOVE CEILING FOR SERVICE CARRIER.
 REFER TO ARCHITECTURAL LAB EQUIPMENT DRAWINGS FOR EXACT LOCATION OF SERVICE CARRIERS.

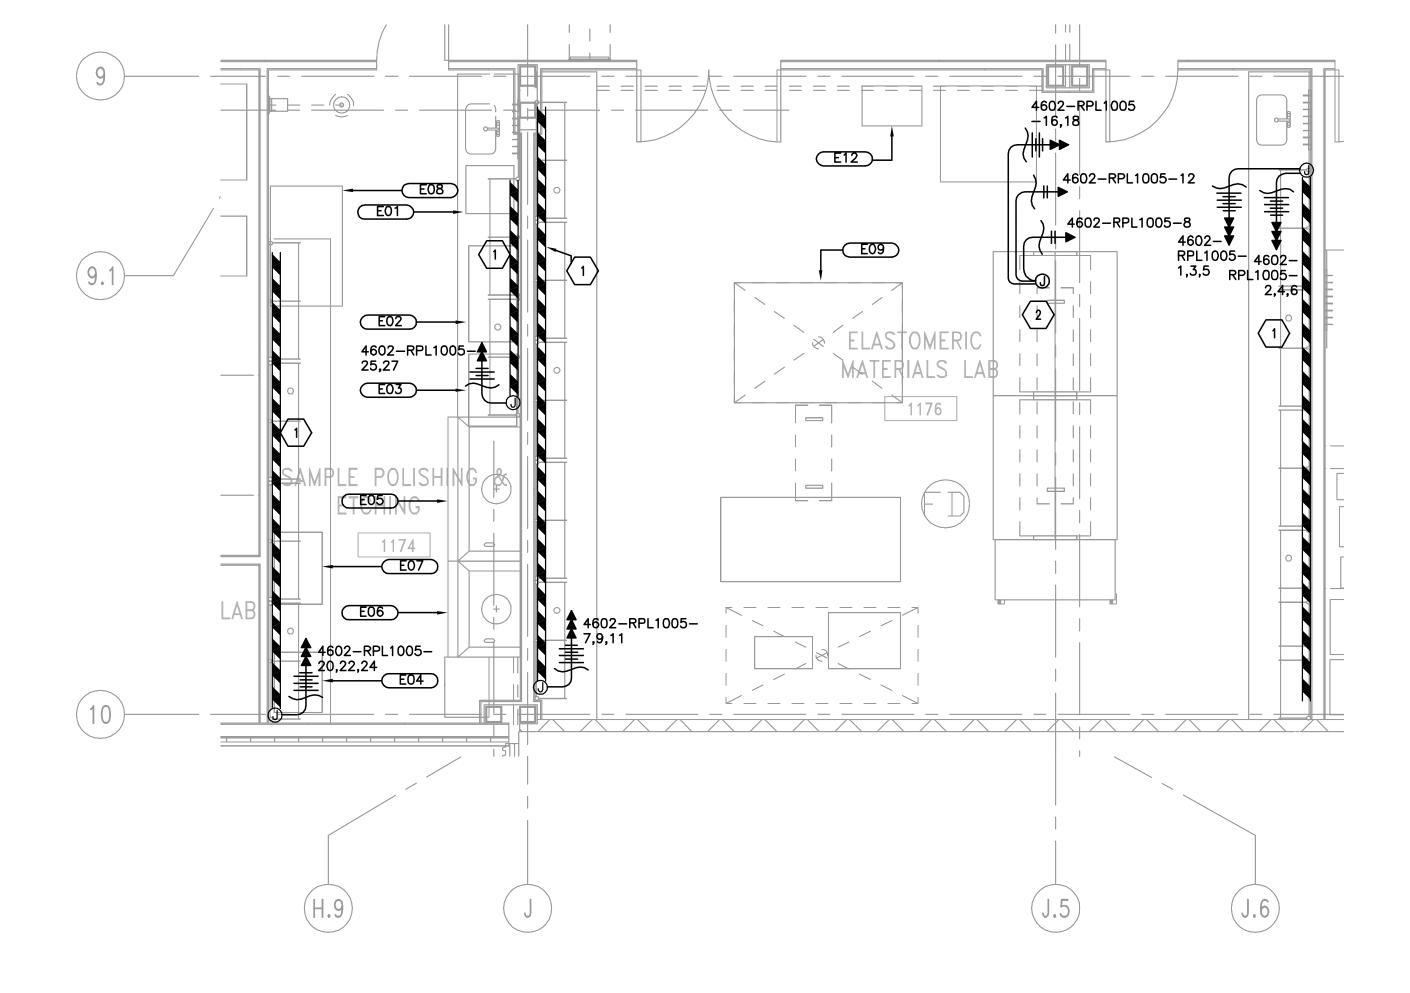



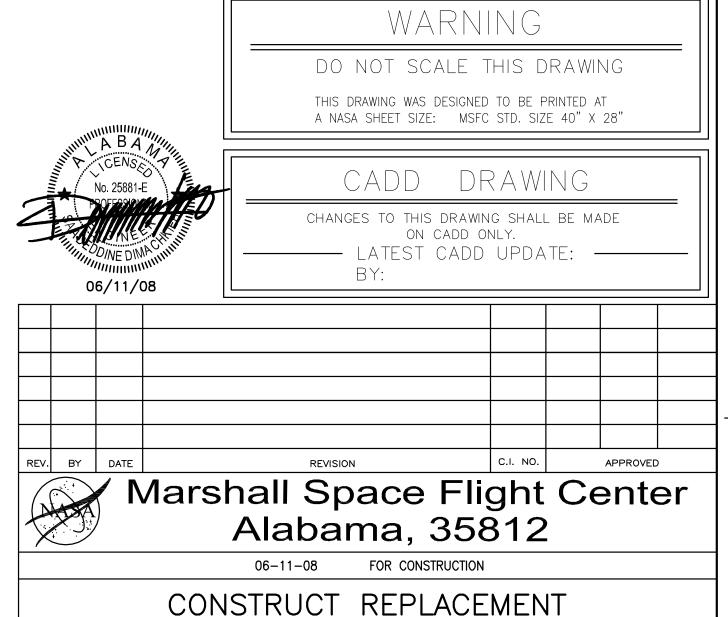

CONSTRUCT REPLACEMENT BUILDING 4602

ENLARGED PLANS

AE FIRM: HELLMUTH, OBATA, + KASSABAUM, Inc. APPROVAL RECOMMENDED:
ROBERT T. MATHIS
AD22 PROJECT A/E

APPROVAL RECOMMENDED:
DENNIS FOSTER
AD22 SUPPORT A/E

APPROVAL RECOMMENDED:
MARK HENDERSON
AD22 TEAM LEAD


SPEC. NO. FAC M5030 VINCENT JAMES GUARIN SAADEDDINE DIMACHKIEH AB22 GROUP LEAD DATE:

DRAWING NO. SIGNATURES ON INDEX SHEET INDICATE AE: DATE: 06-11-08
ACCEPTANCE OF THIS SHEET DESIGNED A. ALMANZA
 DRAWN CHECKED
 R. POBLETE S. DIMACHKIEH

 53 OF 81
 SCALE:
 1/4"=1'-0"
 FAC-A-4602-E624 SHEET 355 OF 445

ECTRICAL SIGNATION	LAB DESIGNATION	EQUIPMENT DESCRIPTION	PANEL CIRCUIT No.	WIRING & CONDUIT	CONNECTION TYPE	MOUNTING HEIGHT	REMARKS
E01	EM40 3.1.65-1	CARBOLITE OVEN					NOTE 1
E02	EM40 3.1.65-2	FISHER OVEN					NOTE 1
E03	EM40 3.1.65-3	SMALL LINDBERG FURNACE					NOTE 1
E04	EM40 3.1.65-4	MEDIUM LINDBERG OVEN					NOTE 1
E05	EM40 3.1.65-5	LARGE LINDBERG OVEN					NOTE 1
E06		NOT USED					
E07	EM40 3.1.65-7	REFRIGERATOR/FREEZER					NOTE 1
E08	EM40 3.1.65-8	FREEZER					NOTE 1
E09		NOT USED					
E10	EM40 3.1.65-10	AUTOCLAVE-OUTSIDE					NOTE 1
E11	EM40 3.1.65-11	AUTOCLAVE CONTROLLER					NOTE 1
E12	EM40 3.1.65-12	AUTOCLAVE- VACUUM PUMP #2					NOTE 1
E13	EM40 3.1.65-13	AUTOCLAVE- VACUUM PUMP #1					NOTE 1
E14	EM40 3.1.65-15	BLUE M DRYING OVEN					NOTE 1
E15	EM40 3.1.65-18	BALL MILL					NOTE 1
E16	EM40 3.1.65-19	TABLE TOP SCALE					NOTE 1
E17	EM40 3.1.65-20	TABLE TOP MIXER					NOTE 1
E18	EM40 3.1.65-21	ATTRITION MILL					NOTE 1
E19	EM40 3.1.65-22	ATTRITION MILL TORQUE METER					NOTE 1
E20	EM40 3.1.65-23	GRIEVE OVEN					NOTE 1
E21	EM40 3.1.65-24	SYBRON OVEN					NOTE 1
E22	EM40 3.1.65-25	CRESS OVEN					NOTE 1
E23	EM40 3.1.65-26	INERT PURGE LINDBERG FURNACE					NOTE 1
E24	EM40 3.1.65-29	I TON CAPACITY CRANE					NOTE 1

NOTE 1: BRANCH CIRCUITS FROM PANELBOARDS TO LAB EQUIPMENT SHOWN ON THIS SCHEDULE ARE NOT IN CONTRACT (TO BE PROVIDED BY OTHERS).

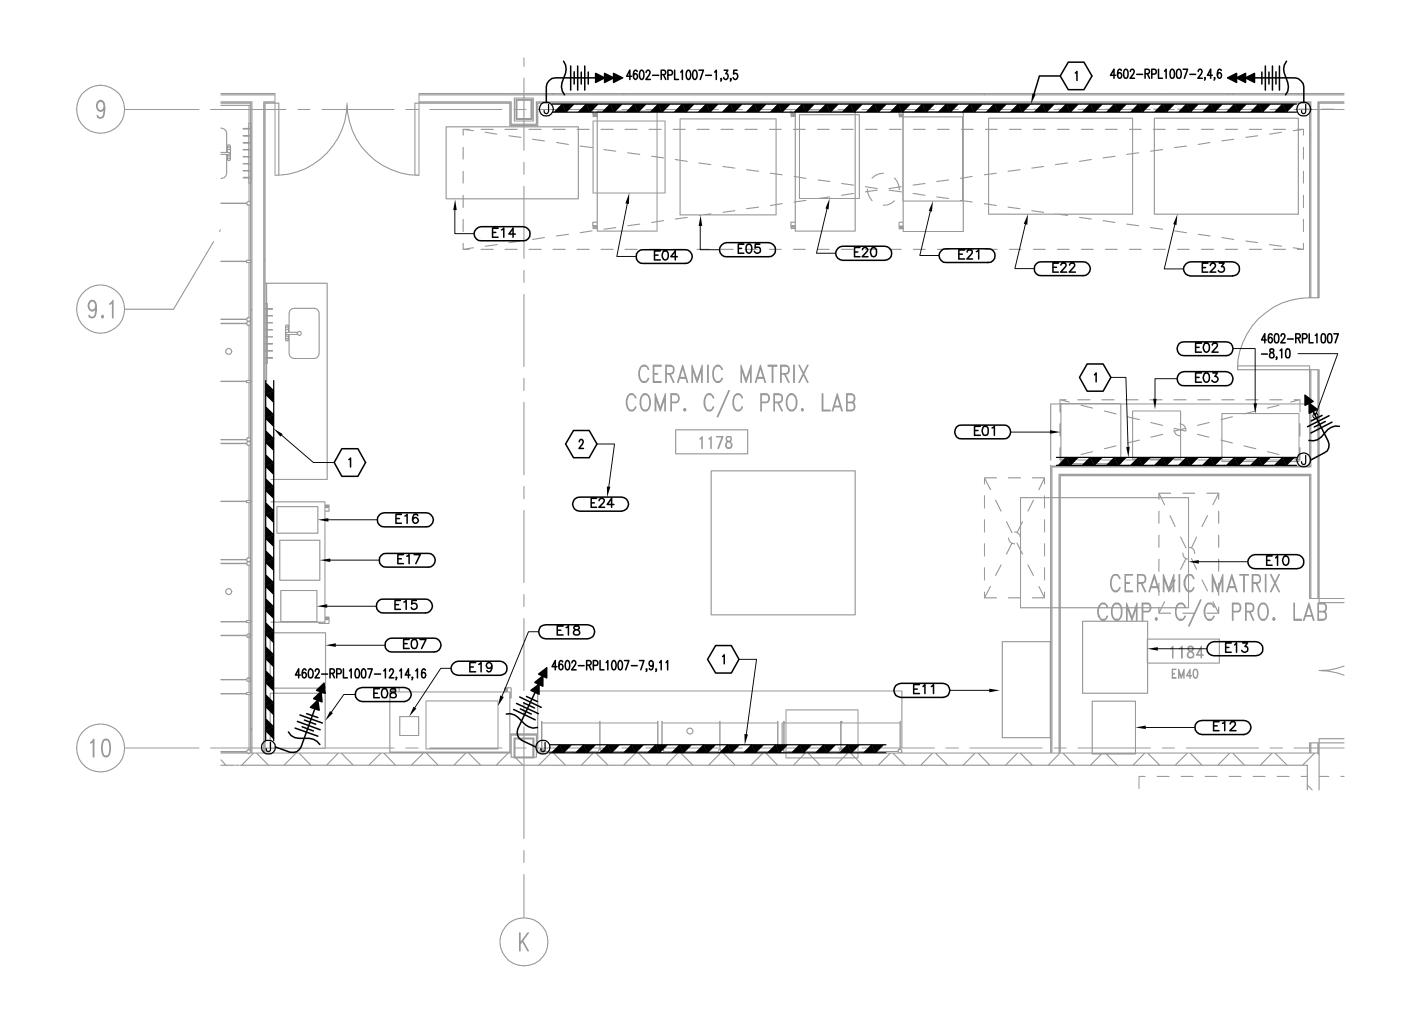




GENERAL NOTES:

- 1. REFER TO E001 FOR ABBREVIATIONS, SYMBOLS AND GENERAL NOTES.
- 2. PROVIDE DUPLEX ON RACEWAY EVERY 12" ON CENTER.
- 3. PROVIDE GFI OUTLET IN RACEWAY WHEN WITHIN 72" OF SINK.

KEY NOTES:

- WIREMOLD G4000 OR EQUAL DUAL CHANNEL RACEWAY SERVING BOTH POWER AND TELECOM. PROVIDE A DUPLEX RECEPTACLE 2'-0" ON CENTER UNLESS OTHERWISE NOTED PROVIDE GFI TYPE RECEPTACLE WHEN LOCATED WITHIN 6'-0" OF A SINK.
- 2 REFER TO ARCHITECTURAL LAB PLANS FOR EXACT LOCATION.

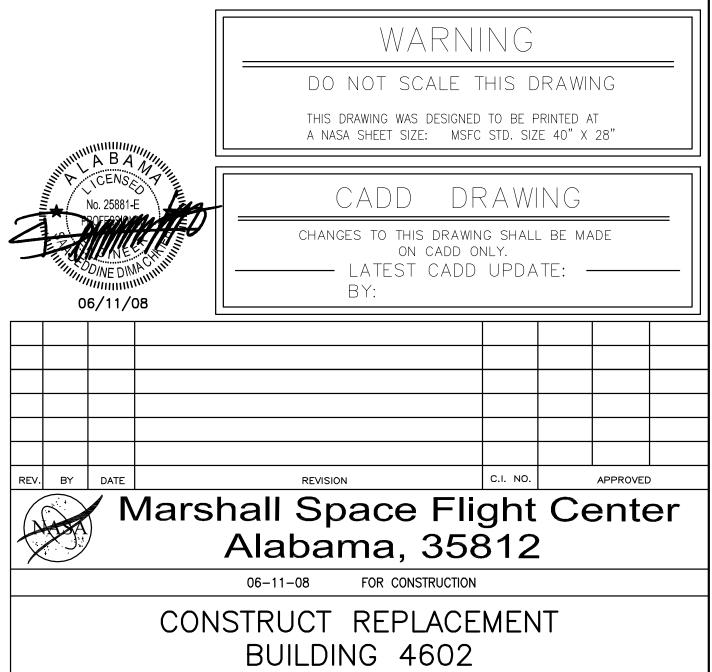

ENLARGED PLANS

AE FIRM: HELLMUTH, OBATA, + KASSABAUM, Inc.

APPROVAL RECOMMENDED:
ROBERT T. MATHIS
AD22 PROJECT A/E

APPROVAL RECOMMENDED:
DENNIS FOSTER
AD22 SUPPORT A/E

APPROVAL RECOMMENDED:
MARK HENDERSON
AD22 TEAM LEAD


SPEC. NO. FAC M5030 VINCENT JAMES GUARIN SAADEDDINE DIMACHKIEH AB22 GROUP LEAD DATE:


DRAWING NO.
 DRAWN CHECKED
 R. POBLETE S. DIMACHKIEH


 54 OF 81
 SCALE:
 1/4"=1'-0"
 FAC - A-4602-E625 SHEET 356 OF 445


SIGNATURES ON INDEX SHEET INDICATE AE: DATE: 06-11-08

ACCEPTANCE OF THIS SHEET DESIGNED A. AI MAN7A

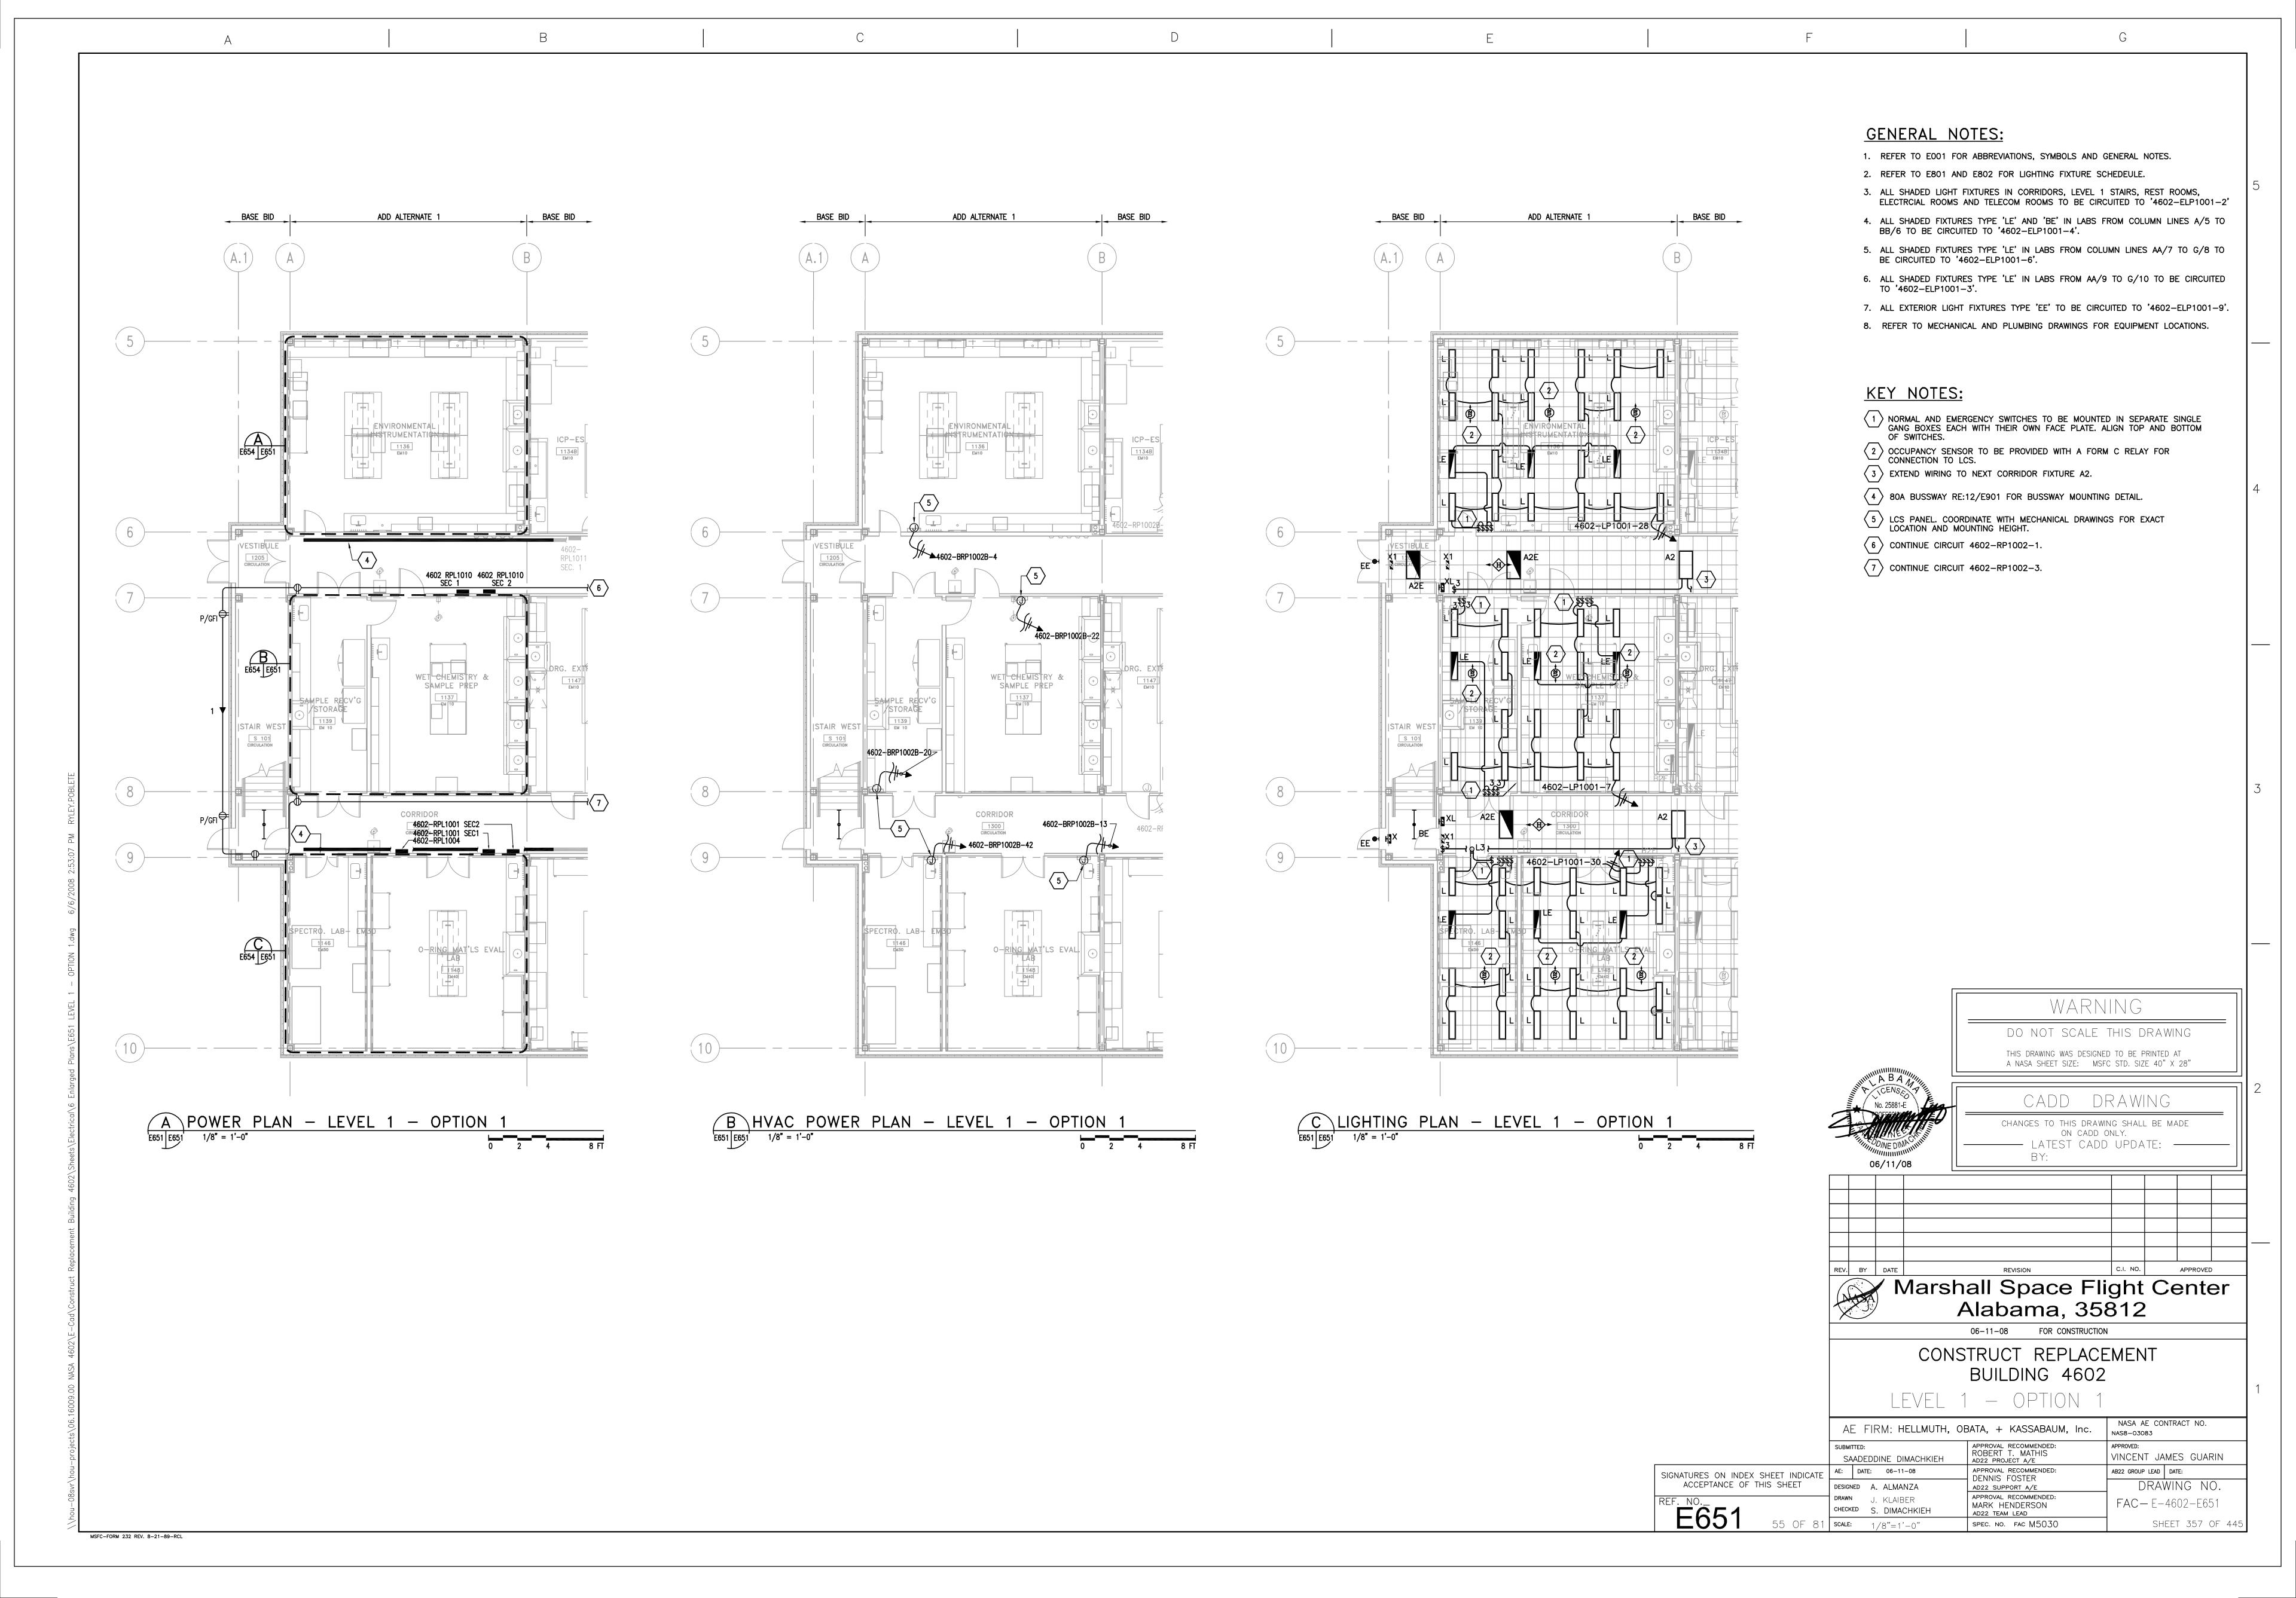

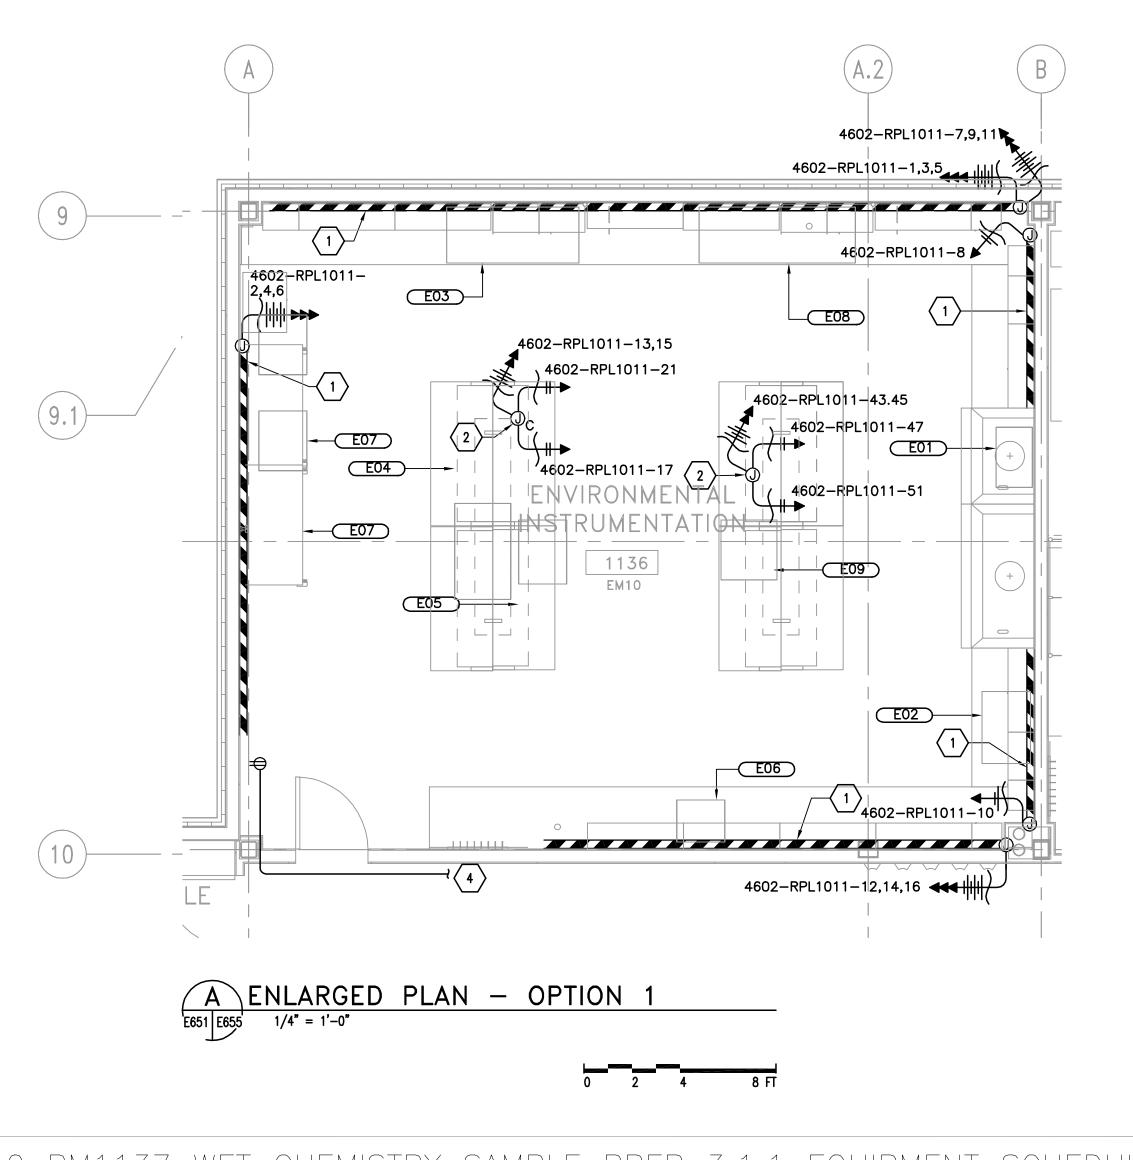

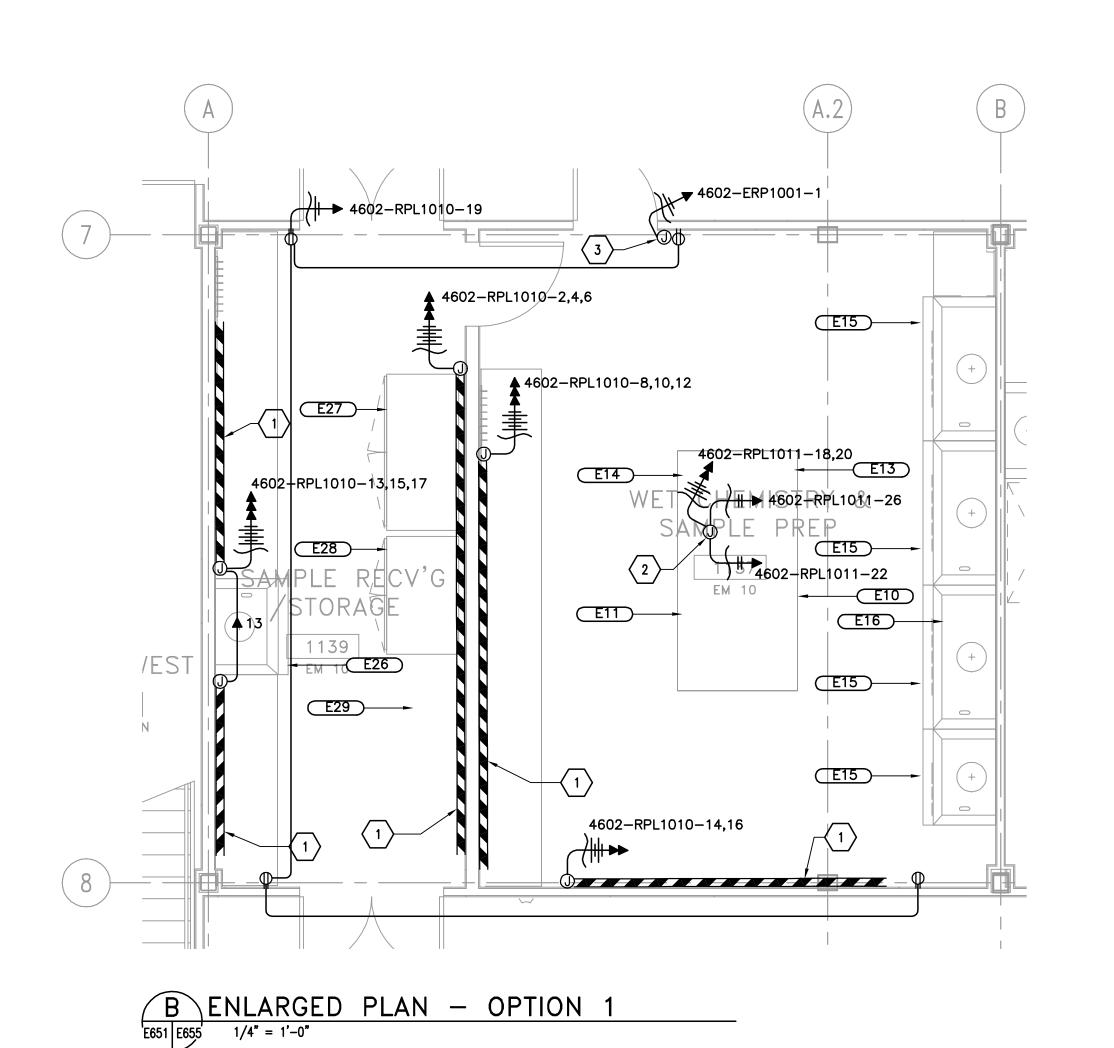

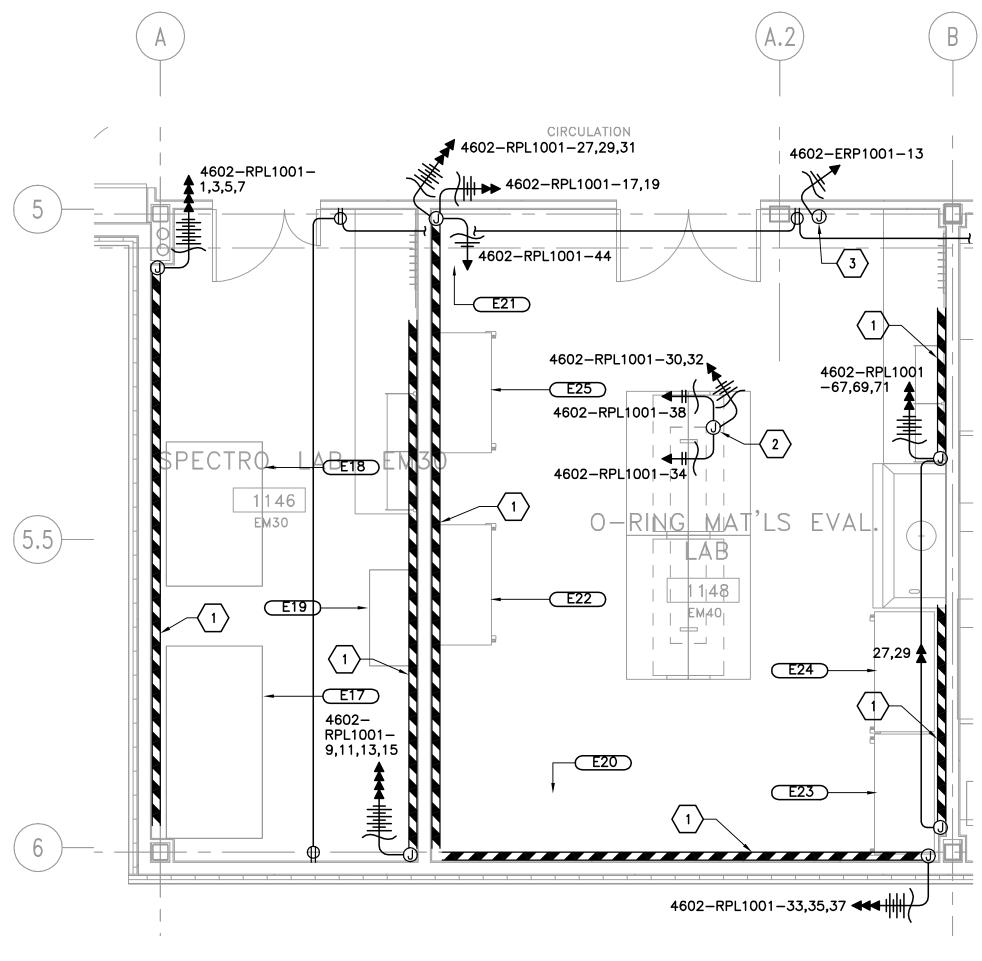

C ENLARGED PLAN — OPTION 1

E651 E655 1/4" = 1'-0"

0 2 4 8 1

	EM10 RM1137 WET	CHEMISTRY	SAMPLE PREF	3.1.1 EQ	UIPMEN	T SCHEDULE
LAB DESIGNATION	EQUIPMENT DESCRIPTION	PANEL CIRCUIT No.	WIRING & CONDUIT	CONNECTION TYPE	MOUNTING HEIGHT	REMARKS
EM10 3.1.1-1	CALORIMETER					NOTE 1
EM10 3.1.1-2	MICROWAVE					NOTE 1
	NOT USED					
EM10 3.1.1-4	DRYING OVEN					
EM10 3.1.1-5	SULPHER ANALYZER					NOTE 1
EM10 3.1.1-6	FUMEHOOD					NOTE 1
EM10 3.1.1-7	WATERBATH					NOTE 1
	EM10 3.1.1-1 EM10 3.1.1-2 EM10 3.1.1-4 EM10 3.1.1-5 EM10 3.1.1-6 EM10	LAB DESIGNATION EM10 3.1.1-1 EM10 3.1.1-2 MICROWAVE 3.1.1-2 NOT USED EM10 3.1.1-4 EM10 3.1.1-5 EM10 3.1.1-5 EM10 3.1.1-6 EM10 WATERBATH	LAB DESIGNATION EM10 3.1.1-1 EM10 3.1.1-2 MICROWAVE NOT USED EM10 3.1.1-4 EM10 3.1.1-5 EM10 SULPHER ANALYZER EM10 3.1.1-6 EM10 WATERBATH	LAB DESIGNATION DESCRIPTION CIRCUIT No. WIRING & CONDUIT EM10 3.1.1-1 EM10 3.1.1-2 NOT USED EM10 3.1.1-4 EM10 DRYING OVEN 3.1.1-5 EM10 SULPHER ANALYZER 3.1.1-6 EM10 WATERBATH	LAB DESIGNATION DESCRIPTION PANEL CIRCUIT No. CONDUIT TYPE EM10 3.1.1-1 EM10 3.1.1-2 NOT USED EM10 3.1.1-4 EM10 3.1.1-4 EM10 3.1.1-5 EM10 3.1.1-5 EM10 SULPHER ANALYZER 3.1.1-6 EM10 WATERBATH	DESIGNATION DESCRIPTION CIRCUIT No. CONDUIT TYPE HEIGHT EM10 3.1.1-1 EM10 3.1.1-2 NOT USED EM10 3.1.1-4 EM10 3.1.1-5 EM10 3.1.1-6 FUMEHOOD 3.1.1-6 EM10 WATERBATH

	E	M30 RM1146 SPE	ECTRO LAB 3	.1.43B EQUIP	MENT SCHE	DULE	
ELECTRICAL DESIGNATION	LAB DESIGNATION	EQUIPMENT DESCRIPTION	PANEL CIRCUIT No.	WIRING & CONDUIT	CONNECTION TYPE	MOUNTING HEIGHT	REMARKS
E17	EM30 3.1.43B-1	OPTICAL BENCH				NOTE	. 1
E18	EM30 3.1.43B-2	OPTICAL BENCH				NOTE	: 1
E19	EM30 3.1.43B-3	CRYO DEWAR, CHILLER				NOTE	: 1

	1				1													
NOTE 1: BRANCH CIRCUITS	FROM	PANELBOARDS	TO L	B EQUIPMENT	SHOWN	ON	THIS	SCHEDULE	ARE	NOT I	N C	CONTRACT	(TO	BE	PROVIDED	BY	OTHERS).	

	E	M40 RM1148 0-F	RING MAT'LS	EVAL. LAB 3	.1.72 EQUIPN	MENT S	SCHEDULE
ELECTRICAL DESIGNATION	LAB DESIGNATION	EQUIPMENT DESCRIPTION	PANEL CIRCUIT No.	WIRING & CONDUIT	CONNECTION TYPE	MOUNTING HEIGHT	REMARKS
E20	EM40 3.1.72-1	HOLOMETRIX THERMAL CONDUCTIVITY INSTR. W/CHILLER					NOTE 1
E21	EM40 3.1.72-2	LASER MICROMETER W/CONTROL BOX					NOTE 1
E22	EM40 3.1.72-3	MOONEY VISCOMETER					NOTE 1
E23	EM40 3.1.72-X	MANSANTO RHEOMETER					NOTE 1
E24	EM40 3.1.72-X	BENCH HARDNESS METER					NOTE 1
E25	EM40 3.1.72-X	PORTABLE RELISTANCY TEST BOX					NOTE 1

3.1.72-X NOTE 1: BRANCH CIRCUITS FROM PANELBOARDS TO LAB EQUIPMENT SHOWN ON THIS SCHEDULE ARE NOT IN CONTRACT (TO BE PROVIDED BY OTHERS).

	EM10 RM1139 SAMPLE RECV'G 3.1.3 EQUIPMENT SCHEDULE											
DESIGNATION E26	LAB DESIGNATION	EQUIPMENT DESCRIPTION	PANEL CIRCUIT No.	WIRING & CONDUIT	CONNECTION TYPE	MOUNTING HEIGHT	REMARKS					
E27	EM10 3.1.3-1	FUMEHOOD				NOTE 1						
E28	EM10 3.1.3-2	REFRIGERATOR				NOTE 1						
E29	EM10 3.1.3-3	REFRIGERATOR				NOTE 1						
	EM10 3.1.3-4	ICE MAKER										
NOTE 1: BRAN	NCH CIRCUITS	FROM PANELBOARDS TO LAB EQUIPMENT	SHOWN ON THIS SCHEDULE	ARE NOT IN CONTRACT (TO BE F	PROVIDED BY OTHERS).							

EM10 RM1136 ENVIRONMENTAL INSTRUMENTATION 3.1.2 EQUIPMENT SCHEDULE


LECTRICAL ESIGNATION	LAB DESIGNATION	EQUIPMENT DESCRIPTION	PANEL CIRCUIT No.	WIRING & CONDUIT	CONNECTION TYPE	MOUNTING HEIGHT	REMARKS
E01	EM10 3.1.2-1	CYANIDE DIGESTION					NOTE 1
E02	EM10 3.1.2-2	SONIC DISMEMBRATOR					NOTE 1
E03	EM10 3.1.2-3	HPLC					NOTE 1
E04	EM10 3.1.2-4	CHROMATOGRAPH					NOTE 1
E05	EM10 3.1.2-5	CONVECTION OVEN					NOTE 1
E06	EM10 3.1.2-6	GLASSWARE WASHER					NOTE 1
E07	EM10 3.1.2-7	BALANCE					NOTE 1
E08	EM10 3.1.2-8	UV SPECTROMETER					NOTE 1
E09	EM10 3.1.2-9	PH METER					NOTE 1

GENERAL NOTES:

1. REFER TO E001 FOR ABBREVIATIONS, SYMBOLS AND GENERAL NOTES.

KEY NOTES:

- WIREMOLD G4000 OR EQUAL DUAL CHANNEL RACEWAY SERVING BOTH POWER AND TELECOM. PROVIDE A DUPLEX RECEPTACLE 1'-0" ON CENTER UNLESS OTHERWISE NOTED PROVIDE GFI TYPE RECEPTACLE WHEN LOCATED WITHIN 6'-0" OF A SINK.
- JUNCTION BOX LOCATED ABOVE CEILING FOR SERVICE CARRIER.
 REFER TO ARCHITECTURAL LAB EQUIPMENT DRAWINGS FOR EXACT LOCATION OF SERVICE CARRIERS.
- 3 PROVIDE JUNCTION BOX FOR OXYGEN SENSOR.
- WIRE RECEPTACLE TO 4602-RPL1011-41

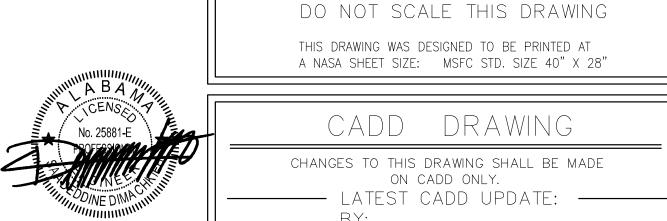

REV. BY DATE REVISION C.I. NO. APPROVED

Marshall Space Flight Center
Alabama, 35812

06-11-08 FOR CONSTRUCTION

WARNING


CONSTRUCT REPLACEMENT BUILDING 4602

ENLARGED PLANS - OPTION 1

AE FIRM: HELLMUTH, OBATA, + KASSABAUM, Inc. APPROVAL RECOMMENDED: ROBERT T. MATHIS AD22 PROJECT A/E VINCENT JAMES GUARIN SAADEDDINE DIMACHKIEH SIGNATURES ON INDEX SHEET INDICATE

ACCEPTANCE OF THE CHIEF AB22 GROUP LEAD DATE: APPROVAL RECOMMENDED: DENNIS FOSTER DRAWING NO. ACCEPTANCE OF THIS SHEET DESIGNED A. ALMANZA AD22 SUPPORT A/E APPROVAL RECOMMENDED: FAC- E-4602-E654 MARK HENDERSON AD22 TEAM LEAD CHECKED S. DIMACHKIEH 58 OF 81 **SCALE**: 1/4"=1'-0" SHEET 360 OF 445 SPEC. NO. FAC M5030

PL1011-41

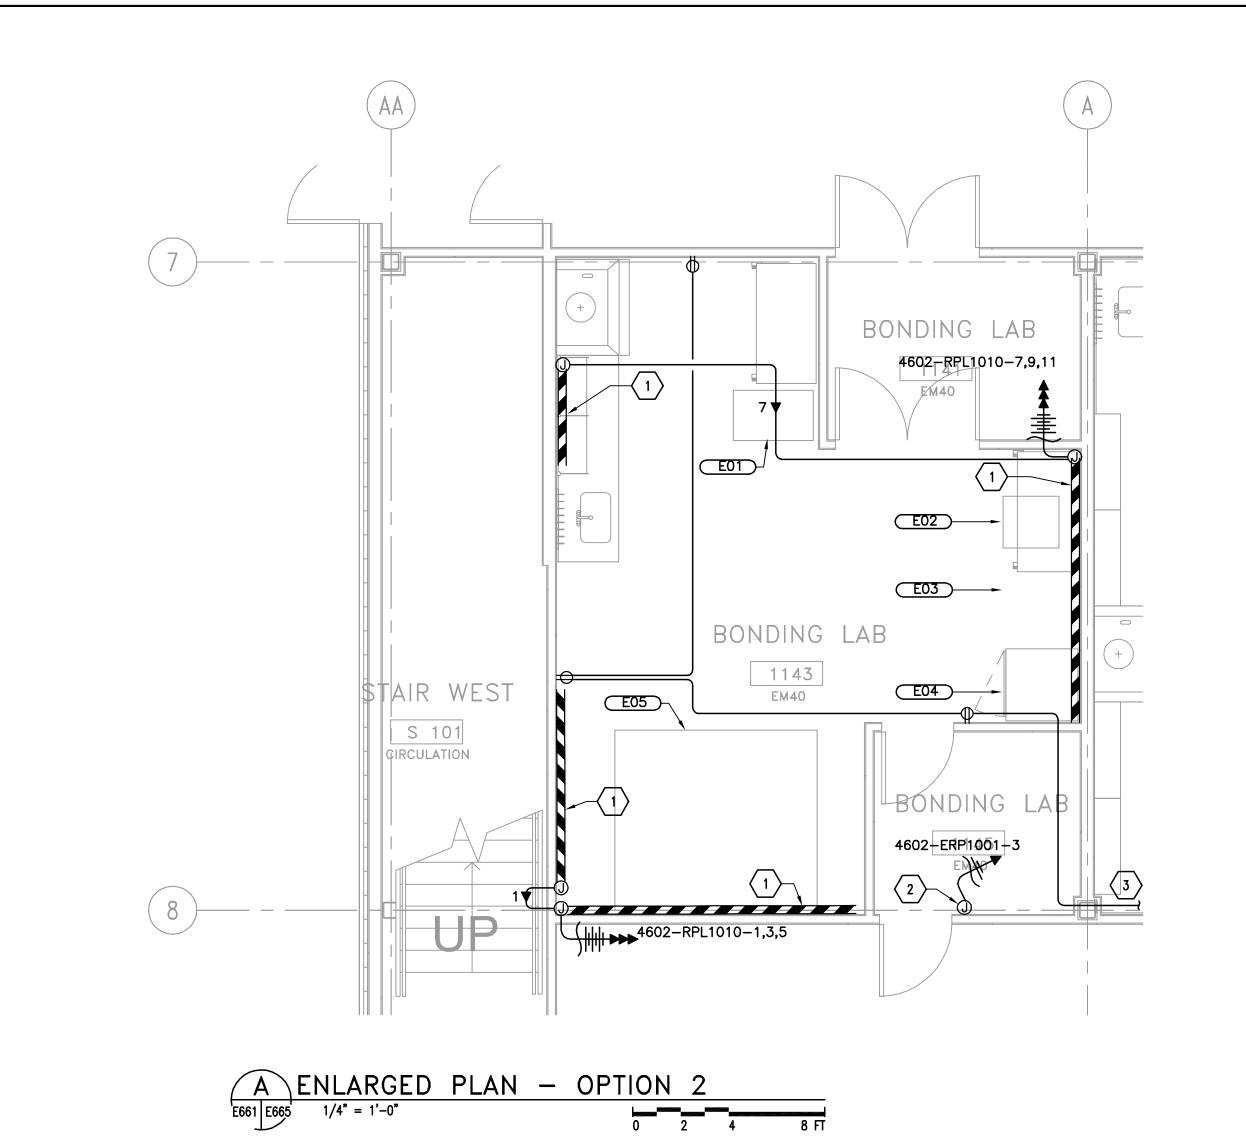


	EM40 RM1143 BONDING LAB 3.1.71 EQUIPMENT SCHEDULE												
ELECTRICAL DESIGNATION	LAB DESIGNATION	EQUIPMENT DESCRIPTION	PANEL CIRCUIT No.	WIRING & CONDUIT	CONNECTION TYPE	MOUNTING HEIGHT	REMARKS						
E01	EM40 3.1.71-X	VACUUM SYSTEM					NOTE 1						
E02	EM40 3.1.71-X	VACUUM MIXER					NOTE 1						
E03	EM40 3.1.71-X	REFRIGERATOR					NOTE 1						
E04	EM40 3.1.71-X	FREEZER					NOTE 1						
E05	EM40 3.1.71-X	OVEN					NOTE 1						

GENERAL NOTES:

1. REFER TO E001 FOR ABBREVIATIONS, SYMBOLS AND GENERAL NOTES.

KEY NOTES:

- WIREMOLD G4000 OR EQUAL DUAL CHANNEL RACEWAY SERVING BOTH POWER AND TELECOM. PROVIDE A DUPLEX RECEPTACLE 1'-0" ON CENTER UNLESS OTHERWISE NOTED PROVIDE GFI TYPE RECEPTACLE WHEN LOCATED WITHIN 6'-0" OF A SINK.
- 2 PROVIDE JUNCTION BOX FOR OXYGEN SENSOR.
- 3 WIRE RECEPTACLES TO 4602-RPL1010-19.

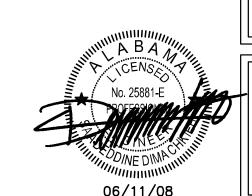

THIS DRAWING WAS DESIGNED TO BE PRINTED AT A NASA SHEET SIZE: MSFC STD. SIZE 40" X 28" CADD DRAWING CHANGES TO THIS DRAWING SHALL BE MADE
ON CADD ONLY.
LATEST CADD UPDATE:

WARNING

DO NOT SCALE THIS DRAWING

G

Marshall Space Flight Center Alabama, 35812 06-11-08 FOR CONSTRUCTION

> CONSTRUCT REPLACEMENT BUILDING 4602

ENLARGED PLANS - OPTION 2

AE FIRM: HELLMUTH, OBATA, + KASSABAUM, Inc. APPROVAL RECOMMENDED: ROBERT T. MATHIS AD22 PROJECT A/E VINCENT JAMES GUARIN SAADEDDINE DIMACHKIEH AB22 GROUP LEAD DATE: APPROVAL RECOMMENDED: DENNIS FOSTER

AD22 SUPPORT A/E

APPROVAL RECOMMENDED:


MARK HENDERSON

AD22 TEAM LEAD DRAWING NO. FAC- E-4602-E665 CHECKED S. DIMACHKIEH 65 OF 81 scale: 1/4"=1'-0" SHEET 367 OF 445 SPEC. NO. FAC M5030

SIGNATURES ON INDEX SHEET INDICATE ACCEPTANCE OF THIS SHEET DATE: 06-11-08

DESIGNED A. AL MAN7A

E665

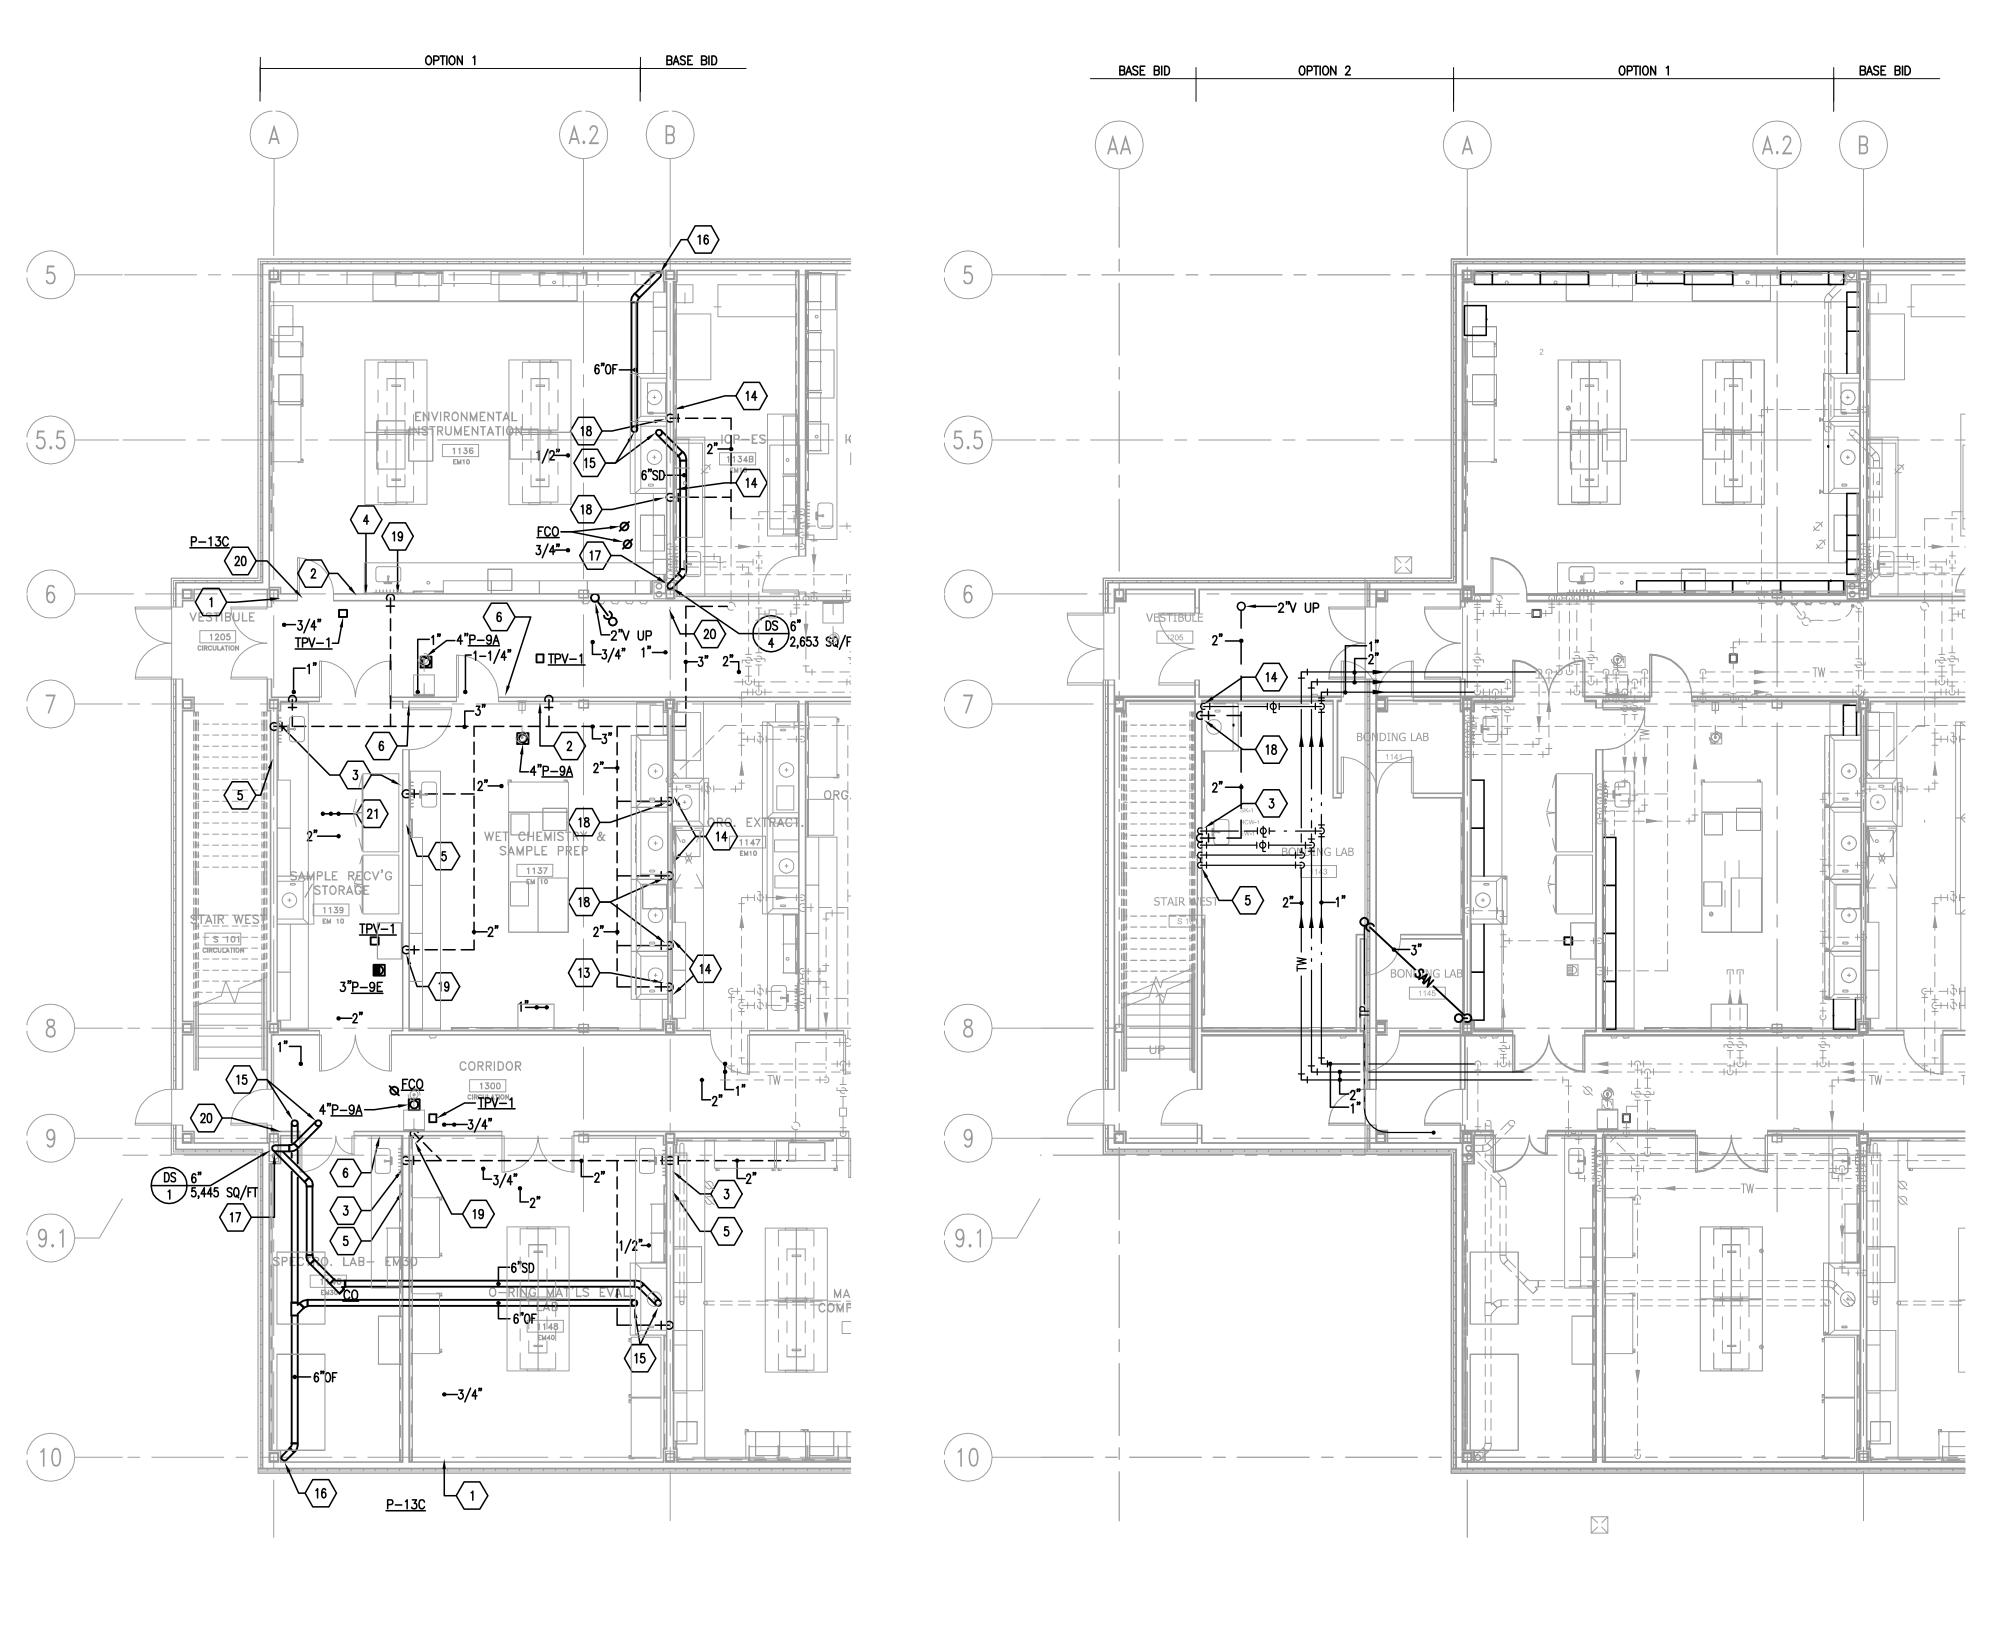

FLOOR PLAN - LEVEL 1 - OPTION 1

A PLUMBING SERVICES PIPING

P403 1/8" = 1'-0"

MSFC-FORM 232 REV. 8-21-89-RCL

FLOOR PLAN — LEVEL 1 — OPTION 2

B PLUMBING SERVICES PIPING

P403 1/8" = 1'-0"

KEY NOTES:

- $\langle 1 \rangle$ 3/4" COLD WATER DOWN TO BELOW SLAB TO SERVE <u>P-13C.</u>
- $\langle 2 \rangle$ 1/2" COLD WATER FROM <u>TPV</u> DOWN TO BELOW SLAB TO SERVE FLOOR DRAIN(S).
- 3 1/2" COLD AND HOT WATER DOWN TO SERVE SINK(S); 2" WASTE DOWN TO BELOW SLAB AND 2" VENT UP.
- 2" TEMPERED WATER DOWN; PROVIDE 1/2" CONNECTION TO EYEWASH AT SINK AND 1-1/4" TO EMERGENCY SHOWER/EYEWASH; CONTINUE 2" TEMPERED WATER UP AND OFFSET ABOVE CEILING.
- 2" TEMPERED WATER DOWN; PROVIDE 1/2" CONNECTION TO EYEWASH AT SINK; CONTINUE 2" TEMPERED WATER UP AND OFFSET ABOVE CEILING.
- 6 2" TEMPERED WATER DOWN; PROVIDE 1-1/4" CONNECTION TO EMERGENCY SHOWER/EYEWASH; CONTINUE 2" TEMPERED WATER UP AND OFFSET ABOVE CEILING.
- $\left\langle \overline{7} \right\rangle$ 1/2" COLD WATER DOWN TO OWNER FURNISHED EQUIPMENT.
- $\langle 8 \rangle$ 1/2" COLD WATER FROM <u>TPV-1</u> DOWN TO BELOW SLAB TO SERVE <u>P-9E.</u>
- $\langle 9 \rangle$ 2" COLD WATER AND 3/4" HOT WATER DOWN TO SERVE FIXTURES.
- $\langle 10 \rangle 3/4$ " COLD WATER AND 1/2" HOT WATER DOWN TO SERVE FIXTURES.
- (11) 1/2" COLD WATER DOWN TO SERVE FIXTURE. \langle 12 \rangle 1" COLD WATER DOWN TO RPZ BELOW AND UP TO OFFSET ABOVE CEILING.
- $\langle 13 \rangle$ 3" waste and vent with 2" P-trap for hood washdown drain.
- $\langle 14 \rangle 1/2$ " cold water down to outlet at cup sink in hood.
- $\langle 15 \rangle$ 6" STORM AND OVERFLOW DRAIN FROM ABOVE.
- 6" OVERFLOW DRAIN DOWN, TERMINATE OVERFLOW DRAIN THRU WALL WITH DOWNSPOUT NOZZLE AT 12" ABOVE FINISHED FLOOR.
- $\langle 17 \rangle$ 6" STORM DRAIN DOWN TO BELOW SLAB.
- (18) 2" WASTE AND VENT.
- $\overline{\left\langle 19\right\rangle}$ 2" VENT FROM BELOW.
- 20 3/4" COLD WATER UP TO PENTHOUSE.
- $\overline{\langle 21 \rangle}$ OCCURS OPTION 1 ONLY.

WARNING DO NOT SCALE THIS DRAWING THIS DRAWING WAS DESIGNED TO BE PRINTED AT A NASA SHEET SIZE: MSFC STD. SIZE 40" X 28"

CADD DRAWING CHANGES TO THIS DRAWING SHALL BE MADE
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LATEST CADD UPDATE:

Marshall Space Flight Center Alabama, 35812

CONSTRUCT REPLACEMENT

06-11-08 FOR CONSTRUCTION

BUILDING 4602

LEVEL 1- OPTIONS 1 AND 2

AE FIRM: HELLMUTH, OBATA, + KASSABAUM, Inc. APPROVAL RECOMMENDED: ROBERT T. MATHIS AD22 PROJECT A/E VINCENT JAMES GUARIN GARY MARSH SIGNATURES ON INDEX SHEET INDICATE

ACCEPTANCE OF THE CHIEF AB22 GROUP LEAD DATE: APPROVAL RECOMMENDED: DENNIS FOSTER DRAWING NO. ACCEPTANCE OF THIS SHEET DESIGNED G. MARSH AD22 SUPPORT A/E APPROVAL RECOMMENDED: FAC-A-4602-P403 PHILLIP HENDRIX
AD22 TEAM LEAD CHECKED G. MARSH 22 OF 39 **scale**: NTS SHEET 413 OF 445 SPEC. NO. FAC M5030